



# VILLAGE OF WELLINGTON BINKS POINTE PATHWAY

## CIVIL PLANS

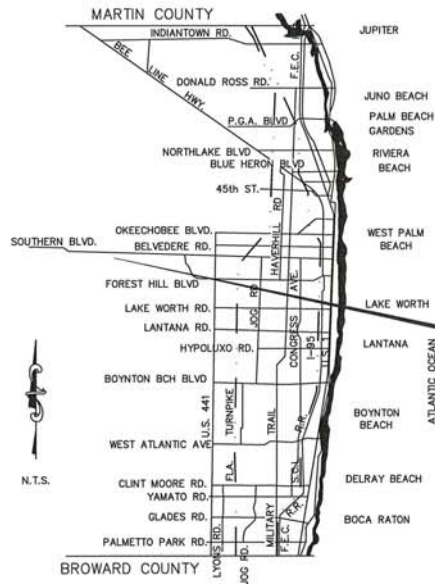

PROJECT

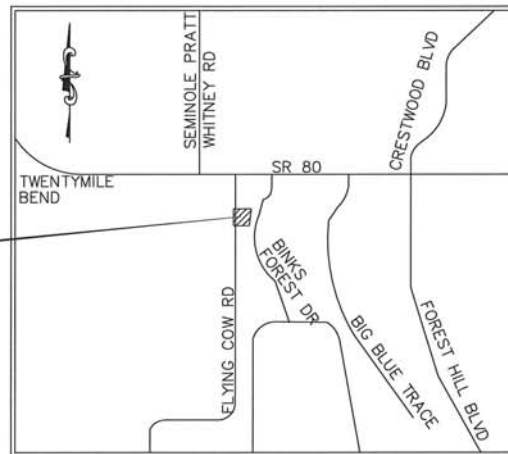

**LOCATION MAP**

NO SCALE

PROJECT LOCATED IN SECTIONS 1&6,  
TOWNSHIP 44 SOUTH, RANGES 40&41 EAST

### SHEET INDEX

C1	COVER SHEET
C2	KEYMAP
C3	GENERAL NOTES AND LEGENDS
C4 - C6	PLAN AND PROFILE
C7	TYPICAL SECTION
C8	GRADING SECTIONS EAST OF CANAL
C-9	STORMWATER POLLUTION PREVENTION PLAN & DETAILS
S1.0 - S3.4	STRUCTURAL PLANS
BP-1	CONTECH PEDESTRIAN BRIDGE DATA SHEET

### VILLAGE OF WELLINGTON OFFICIALS

ANNE GERWIG  
JOHN T. MCGOVERN  
MICHAEL J. NAPOLEONE  
MICHAEL DRAHOS  
TANYA SISKIND

MAYOR  
VICE MAYOR  
COUNCILMAN  
COUNCILMAN  
COUNCILWOMEN

JONATHAN REINSVOLD  
PAUL SCHOFIELD  
TOM LUNDEEN

PROJECT MANAGER  
VILLAGE MANAGER  
VILLAGE ENGINEER

VERTICAL DATUM: NORTH AMERICAN VERTICAL DATUM OF 1988 (NAVD88)  
TO CONVERT TO NGVD29, ADD 1.437' TO THE NAVD88 VALVE.

HORIZONTAL DATUM: NORTH AMERICAN DATUM OF 1983, FLORIDA STATE  
PLANES, EAST ZONE, U.S. FEET (NAD83)

GOVERNING STANDARDS AND SPECIFICATIONS (FDOT STANDARD  
PLANS FY2018-2019)

FLORIDA DEPARTMENT OF TRANSPORTATION, 2018 DESIGN  
STANDARDS AND REVISED INDEX DRAWINGS ARE APPENDED HEREIN  
AND 2018 STANDARD SPECIFICATIONS FOR ROAD AND BRIDGE  
CONSTRUCTION.

PREPARED BY:



2035 Vista Parkway  
West Palm Beach, FL 33411  
Phone No. 561.687.2220  
Fax No. 561.687.1110  
Cert No. 6091 - LB No. 7055

PREPARED FOR:

VILLAGE OF WELLINGTON  
12794 W. FOREST HILL BLVD  
WELLINGTON, FL 33414  
p. 561.791.4052  
f. 561.904.5829

PLANS ARE SCALED TO PLOT ON 11" X 17"  
SHEETS. THE SCALE OF THESE PLANS MAY  
HAVE CHANGED DUE TO REPRODUCTION.

BINKS POINTE PATHWAY

WGI NO.: 2069.03  
PRODUCTION PHASE

100% SUBMITTAL





FM # 438306-1-58-01



STORMWATER TREATMENT AREA 1

"WELLINGTON ENVIRONMENTAL PRESERVE  
GREENWAY PROJECT"  
FM:433196-1-58-01

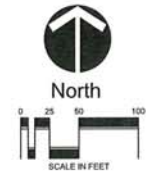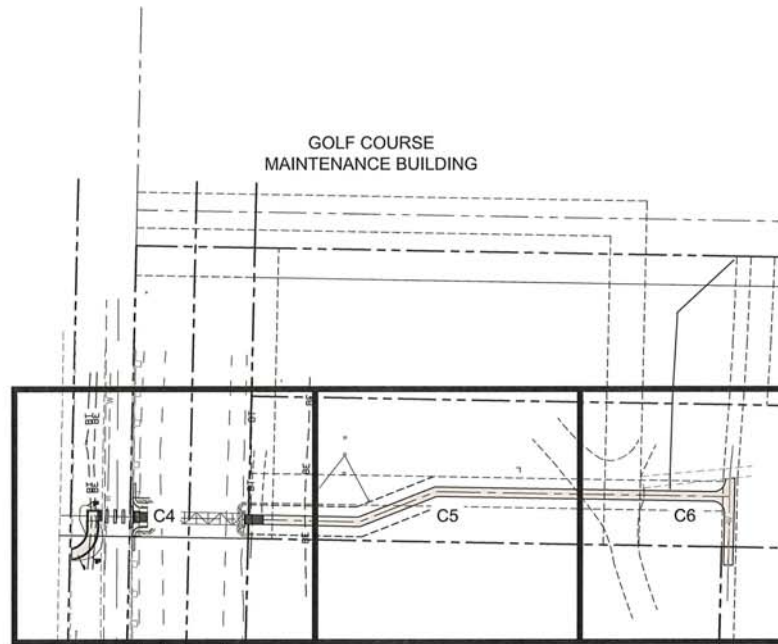

FPL STATION

BINKS FOREST

NAVD88 + 1.437' = NGVD29

PROJECT: BINKS POINT PATHWAY FM# 438306-1-58-01		ENGINEER OF RECORD: THOMAS MUELLER PE PEL 87118		DATE: 8/7/17		SCALE: 1" = 50'		SHEET: C2	
KEYMAP		DESIGNED: TM		CHECKED: TM		BNO		REVISIONS	
TOTAL SHEETS: 9		DRAWN: SCC		DESIGNED: SCC		BNO		NO. DATE DESCRIPTION	
JOB NO: 2008.03		CAO 200803 BPP CIVIL PLANS/ENG		DATE: 8/7/17		BNO		NO. DATE DESCRIPTION	
2008 Vista Parkway Austin, Texas 78704 Tel No. 512.467.2210 Fax No. 512.467.2210 E-mail: info@wgi.com www.wgi.com		WGI							



## GENERAL NOTES

- ALL WORK SHALL CONFORM TO FDOT SPECIFICATIONS AND DESIGN STANDARDS, LATEST EDITION UNLESS SPECIFIED OTHERWISE.
- MAINTENANCE OF TRAFFIC (MOT) WITH FDOT STANDARD INDEX 600.
- ALL WORK FOR THIS PROJECT WILL BE COMPLETED WITHIN AND FROM THE EXISTING RIGHT-OF-WAY.
- WORK INCLUDED:
  - THE CONTRACTOR SHALL FURNISH ALL LABOR, SUPERINTENDENCE, QUALITY CONTROL, MATERIALS, PLANT, POWER, LIGHT, HEAT, FUEL, WATER, TOOL, APPLIANCES, EQUIPMENT, SUPPLIES, AND OTHERS NECESSARY FOR CONSTRUCTION NECESSARY AND PROPER FOR PERFORMING AND COMPLETING THE WORK. CONTRACTOR SHALL PERFORM AND COMPLETE THE WORK IN THE MANNER BEST ADAPTED TO PROMOTE SCHEDULED CONSTRUCTION CONSISTENT WITH SAFETY OF LIFE AND PROPERTY AND TO THE SATISFACTION OF THE OWNER, AND IN STRICT ACCORDANCE WITH THE CONTRACT DOCUMENTS. THE CONTRACTOR SHALL CLEAN UP THE WORK, MAINTAIN IT DURING CONSTRUCTION, AND PAY ALL COSTS INCIDENTAL THERETO. CONTRACTOR SHALL REPAIR OR RESTORE ALL STRUCTURES AND PROPERTY THAT MAY BE DAMAGED OR DISTURBED DURING PERFORMANCE OF THE WORK. THE COST OF INCIDENTAL WORK DESCRIBED IN THESE GENERAL REQUIREMENTS, FOR WHICH THERE ARE NO SPECIFIC CONTRACT ITEMS, SHALL BE CONSIDERED AS A PART OF THE GENERAL COST OF DOING THE WORK AND SHALL BE INCLUDED IN THE PRICES FOR THE VARIOUS CONTRACT ITEMS. NO ADDITIONAL PAYMENT WILL BE MADE THEREFOR.
  - THE CONTRACTOR SHALL PROVIDE AND MAINTAIN SUCH MODERN PLANT, TOOLS, AND EQUIPMENT AS MAY BE NECESSARY IN THE OPINION OF THE ENGINEER TO PERFORM IN A SATISFACTORY AND ACCEPTABLE MANNER ALL THE WORK REQUIRED BY THE OFFICE CONTRACT. ONLY EQUIPMENT OF ESTABLISHED REPUTATION AND PROVEN EFFICIENCY SHALL BE USED. THE CONTRACTOR SHALL BE SOLELY RESPONSIBLE FOR THE ADEQUACY OF WORKMANSHIP, MATERIALS AND EQUIPMENT, PRIOR APPROVAL OF THE ENGINEER NOTWITHSTANDING.
- SHOP DRAWINGS, PRODUCT DATA AND SAMPLES.
  - SUBMIT FIVE (5) COPIES OF ALL REQUIRED SHOP DRAWINGS, PRODUCT DATA AND SAMPLES FOR ENGINEER'S REVIEW.
  - SHOP DRAWINGS, PRODUCT DATA, SAMPLES AND TRANSMITTAL LETTERS PERTAINING THERETO SHALL BE IDENTIFIED WITH THE TITLE OF THE PROJECT, SUBMISSION DATE, AND THE CONTRACTOR'S ACKNOWLEDGEMENT THAT HE HAS REVIEWED THEM AND FOUND THEM ACCEPTABLE.
  - NOTIFY ENGINEER IN WRITING, AT THE TIME OF SUBMITTAL, OF ANY DEVIATIONS IN THE SUBMITTALS FROM THE REQUIREMENTS OF THE CONTRACT DOCUMENTS.
  - THE REVIEW AND APPROVAL OF SHOP DRAWINGS, SAMPLES OR PRODUCT DATA BY THE ENGINEER SHALL NOT RELIEVE THE CONTRACTOR FROM HIS/HER RESPONSIBILITY WITH REGARD TO THE FULFILLMENT OF THE TERMS OF THE CONTRACT DOCUMENTS. ALL RISKS OF ERROR AND OMISSION ARE ASSUMED BY THE CONTRACTOR AND THE ENGINEER WILL HAVE NO RESPONSIBILITY THEREFOR.
- THE LOCATION OF ALL EXISTING UTILITIES SHOWN IN THE PLANS ARE APPROXIMATE ONLY AND ARE BASED ON AS BUILT SURVEY INFORMATION. ADDITIONAL UTILITIES MAY EXIST WHICH ARE NOT SHOWN ON THESE PLANS. THE CONTRACTOR SHALL BE RESPONSIBLE FOR LOCATING AND VERIFYING ALL UTILITIES PRIOR TO BEGINNING CONSTRUCTION, ANY AND ALL KNOWN CONFLICTS WITH EXISTING UTILITIES SHALL BE REPORTED TO THE ENGINEER. THIS WORK BY THE CONTRACTOR SHALL NOT RELIEVE THE CONTRACTOR FROM HIS/HER RESPONSIBILITY WITH REGARD TO THE FULFILLMENT OF THE TERMS OF THE CONTRACT DOCUMENTS. ALL RISKS OF ERROR AND OMISSION ARE ASSUMED BY THE CONTRACTOR AND THE ENGINEER WILL HAVE NO RESPONSIBILITY THEREFOR.

UTILITY OWNERS:	CONTACT	TELEPHONE NO.
AT&T	GARTH BEDWARD	(561) 504-2263
COMCAST CABLEVISION	MYA FISHER	(561) 598-9756
FLORIDA POWER & LIGHT (D)	JORGE SANCHEZ	(561) 616-1512
FLORIDA POWER & LIGHT (T)	TRICIA D'ANNUNZIO	(561) 904-3580
FLORIDA PUBLIC UTILITIES	DALE BUTCHER	(561) 602-3702
VILLAGE OF WELLINGTON	COREY ROBINSON	(561) 753-2464
PBC TRAFFIC OPS	DANNY RODRIGUEZ	(561) 533-3900

- THE CONTRACTOR SHALL NOTIFY THE PROPER UTILITY COMPANY AT LEAST 48 HOURS IN ADVANCE OF ANY EXCAVATION NEAR OR AROUND THEIR FACILITY SO THAT A COMPANY REPRESENTATIVE CAN BE PRESENT.
- THE CONTRACTOR IS TO USE EXTREME CAUTION WHEN WORKING IN OR AROUND AREAS OF OVERHEAD TRANSMISSION LINES AND UNDERGROUND UTILITIES.
- THE CONTRACTOR IS TO PROTECT UNDERGROUND UTILITIES DURING CONSTRUCTION AT ALL TIMES.
- FOR UTILITY ADJUSTMENT SYMBOLS, SEE FDOT STANDARD INDEX 602.
- ANY PUBLIC LAND CORNER MONUMENT WITHIN THE LIMITS OF CONSTRUCTION IS TO BE PROTECTED. IF A CORNER MONUMENT IS IN DANGER OF BEING DESTROYED AND HAS NOT BEEN PROPERLY REFERENCED THE PROJECT ENGINEER SHALL NOTIFY THE COUNTY SURVEYOR WITHOUT DELAY BY TELEPHONE.
- ALL ELEVATIONS ARE REFERENCED TO THE NAVD OF 1988 IN FEET.
- TOPOGRAPHIC SURVEY PERFORMED FOR THIS PROJECT BY CAUFIELD & WHEELER, INC.
- BENCHMARK ORIGIN DESIGNATION: PALM BEACH COUNTY BENCHMARK "ACME" ELEVATION 17.43
- ANY NGVD 29 MONUMENT WITHIN THE LIMITS OF CONSTRUCTION IS TO BE PROTECTED.
- ALL EXISTING TREES & SHRUBS IN CONFLICT WITH PROPOSED PATHWAYS WITHIN R/W SHALL BE REMOVED.
- NEATLY REMOVE OR PRUNE ALL EXIST. TREES, HEDGES AND OTHER VEGETATION (INCLUDING THOSE NOT SHOWN HEREON) AS NECESSARY TO PROVIDE MINIMUM CLEARANCES OF 1 FT HORIZONTAL AND 10 FT VERTICAL FROM THE PROPOSED PATH.
- EXISTING DRAINAGE STRUCTURES AND PIPES WITHIN THE LIMITS OF CONSTRUCTION SHALL REMAIN UNLESS OTHERWISE NOTED.
- ALL EXISTING PIPES THAT ARE TO REMAIN ARE TO BE CLEANED OUT (DESILTED) AS DIRECTED BY THE ENGINEER.
- ALL STATIONS AND OFFSETS ARE FROM THE BASELINE OF CONSTRUCTION TO THE CENTERLINE OF THE PATHWAY UNLESS OTHERWISE NOTED.
- RADI, DIMENSIONS AND ELEVATIONS ARE TO THE CENTERLINE OF THE PATHWAY UNLESS OTHERWISE NOTED.
- PROPOSED GRADES SHOWN ARE FINISH GRADES.
- THE CONTRACTOR SHALL BE RESPONSIBLE FOR PROTECTION OF EXISTING LANDSCAPING AND IRRIGATION SYSTEMS LOCATED ON PRIVATE PROPERTY OR REPLACEMENT OF SYSTEMS DAMAGED BY THE CONTRACTOR SHALL BE MADE AT THE EXPENSE OF THE CONTRACTOR.
- THE CONTRACTOR AND/OR HIS/HER SUBCONTRACTORS SHALL BE IN COMPLIANCE WITH CURRENT OSHA, STATE, COUNTY, AND LOCAL REGULATIONS, WHICH INCLUDE BUT ARE NOT LIMITED TO 54 CFR 45894 AND 29 CFR 1926.560 & 651 AND THE FLORIDA TRENCH SAFETY ACT.
- CONTRACTOR SHALL OBTAIN A DEWATERING GENERAL USE PERMIT FROM THE SOUTH FLORIDA WATER MANAGEMENT DISTRICT PRIOR TO COMMENCING DEWATERING UNLESS THE WORK QUALIFIES FOR A "NO-NOTICE" AUTHORIZATION AS DESCRIBED IN RULE 40C-20.38(2) OF THE FLORIDA ADMINISTRATIVE CODE AND THE HANDLING OF ALL CONTAMINATED MEDIA INCLUDING BUT NOT LIMITED TO GROUND WATER, WASTE WATER, SOILS, SOLID WASTES, SLUDGE, HAZARDOUS WASTES, AIR MONITORING RECORDS AND SAMPLE RESULTS FOR ALL MATERIALS TESTED AND ANALYZED TO THE LAP VILLAGE OF WELLINGTON ENGINEER AND THE FDOT DDC.
- ALL SALVAGEABLE MATERIAL AND EQUIPMENT REMOVED FROM THE EXISTING CONSTRUCTION FOR WHICH SPECIFIC USE, RELOCATION OR OTHER DISPOSAL IS NOT SPECIFICALLY NOTED ON THE DRAWINGS OR OTHERWISE SPECIFIED, SHALL REMAIN THE PROPERTY OF THE OWNER AND SHALL BE TURNED OVER TO HIM/HER. ALL MATERIAL AND EQUIPMENT NOT IN SALVAGEABLE CONDITION AS DETERMINED BY THE ENGINEER, SHALL

## GENERAL NOTES CONTINUED

- BE DISPOSED OF BY THE CONTRACTOR IN A LEGAL MANNER AT THE CONTRACTOR'S EXPENSE. THE ACTUAL STORAGE SITE FOR SALVAGEABLE MATERIAL WILL BE DESIGNATED BY THE OWNER.
- CLEANING
  - DURING THE CONSTRUCTION OF THE WORK, THE CONTRACTOR SHALL, AT ALL TIMES, KEEP THE SITE OF THE WORK AND ADJACENT PREMISES AS FREE FROM MATERIAL, DEBRIS AND RUBBISH AS IS PRACTICABLE, AND SHALL REMOVE THE SAME FROM ANY PORTION OF THE SITE IF, IN THE OPINION OF THE ENGINEER, SUCH MATERIAL, DEBRIS, OR RUBBISH CONSTITUTES A NUISANCE OR IS OBJECTIONABLE.
  - AT THE CONCLUSION OF THE WORK, ALL TOOLS, TEMPORARY STRUCTURES AND MATERIALS BELONGING TO THE CONTRACTOR SHALL BE PROMPTLY TAKEN AWAY AND CONTRACTOR SHALL REMOVE AND PROMPTLY DISPOSE OF ALL RUBBISH OR ANY FOREIGN MATERIALS. THE CONTRACTOR SHALL THOROUGHLY CLEAN ALL MATERIAL INSTALLED AND SHALL DELIVER SUCH MATERIALS UNDAMAGED IN A CLEAN AND NEW CONDITION.
- ALL PAVEMENT STRIPPING SHALL BE THERMOPLASTIC.
- ALL AREAS DISTURBED BY CONSTRUCTION SHALL BE RESTORED TO ORIGINAL CONDITION.
- CONTRACTOR SHALL REPAIR ALL IRRIGATION DAMAGED DURING CONSTRUCTION. CONTRACTOR SHALL BE RESPONSIBLE FOR OBTAINING AND KEEPING ONSITE ALL REQUIRED PERMITS.
- ALL PEDESTRIAN ROUTES SHALL MEET THE REQUIREMENTS OF THE AMERICANS WITH DISABILITIES ACT. CROSS SLOPES SHALL NOT EXCEED 2% AND LONGITUDINAL SLOPES SHALL NOT EXCEED 5%.
- ALL UTILITY CONFLICTS ENCOUNTERED SHALL BE COORDINATED WITH ENGINEER, ITD AND APPROPRIATE UTILITY COMPANY.
- ALL DISTURBED AREAS SHALL BE RE-SEEDDED. BAHIA 500 TO BE USED IN UN-IRRIGATED AREAS UNLESS OTHERWISE NOTED.
- CURB RAMPS SHALL BE PER INDEX 304 FOR THE FDOT DESIGN STANDARDS.
- ATTENTION TO THE FACT THAT THE MAJORITY OF THE WORK WILL BE PERFORMED UNDER EXISTING OVERHEAD POWER LINES SHOULD BE NOTED.
- CONTRACTOR TO BACKFILL ALL EXCAVATIONS AT THE END OF EACH SHIFT TO MEET DROP-OFF CRITERIA IN ACCORDANCE WITH 4:1 TRANSITION DETAIL IN FDOT INDEX 102-600 SHEET 8 OF 12.
- WORK ONLY ALLOWED FROM 7AM TO 5PM MONDAY TO INCLUDING FRIDAY, NO WORK ON WELLINGTON AND STATE GSBTH, METAL, WOOD, GROUND WATER, ETC. WISLE PLANT PROVISION 23 CFR 635.41.
- CONTRACTOR SHALL MEET OSHA REQUIREMENTS WHEN WORKING NEAR POWER LINES.
- FLYING COW RD WILL BE MAINTAINED OPERATIONAL AT ALL TIMES.

## PAVING

- IMMEDIATELY CEASE TRANSPORTATION OF ASPHALT MIXTURES FROM THE PLANT WHEN RAIN BEGINS AT THE ROADWAY, DO NOT PLACE ASPHALT MIXTURES WHILE RAIN IS FALLING, OR WHEN THERE IS WATER ON THE SURFACE TO BE COVERED.
- PRODUCE A FINISHED SURFACE OF UNIFORM TEXTURE AND COMPACTION WITH NO PULLED, TORN, OR LOOSENED PORTIONS AND FREE OF SEGREGATION, AND STREAKS, SAND SPOTS, OR RIPPLES.

## CONTAMINATION

### UNIDENTIFIED AREAS OF CONTAMINATION

WHEN ENCOUNTERING OR EXPOSING ANY ABNORMAL CONDITION INDICATING THE PRESENCE OF A HAZARDOUS OR TOXIC WASTE, OR CONTAMINANTS, CEASE OPERATIONS IMMEDIATELY IN THE VICINITY AND NOTIFY THE LAP VILLAGE OF WELLINGTON ENGINEER. THE PRESENCE OF TANKS OR BARRELS, DISCLOSED EARTH, METAL, WOOD, GROUND WATER, ETC. WISLE PLANT ABNORMAL ODORS, EXCESSIVELY HOT EARTH, SMOKE, OR OTHER CONDITIONS THAT APPEAR ABNORMAL MAY INDICATE HAZARDOUS OR TOXIC WASTES OR CONTAMINANTS AND MUST BE TREATED WITH EXTREME CAUTION.

MAKE EVERY EFFORT TO MINIMIZE THE SPREAD OF CONTAMINATION INTO UNCONTAMINATED AREAS. IMMEDIATELY PROVIDE FOR THE HEALTH AND SAFETY OF ALL WORKERS AT THE JOB SITE AND MAKE PROVISIONS NECESSARY FOR THE HEALTH AND SAFETY OF THE PUBLIC THAT MAY BE EXPOSED TO ANY POTENTIALLY HAZARDOUS CONDITIONS. PROVISIONS SHALL MEET ALL APPLICABLE LOCAL, STATE, AND FEDERAL LAWS, RULES, REGULATIONS OR CODES COVERING HAZARDOUS CONDITIONS AND WILL BE IN A MANNER COMMENSURATE WITH THE GRAVITY OF THE CONDITIONS.

THE LAP VILLAGE OF WELLINGTON ENGINEER AND/OR CONTRACTOR WILL COORDINATE AND MOBILIZE A QUALIFIED CONTAMINATION ASSESSMENT/REMEDIATION (CAR) CONTRACTOR. QUALIFICATIONS OF SUCH CAR CONTRACTOR SHALL INCLUDE, BUT NOT BE LIMITED TO: EXPERIENCE AND PERSONNEL TO PREPARE CONTAMINATION ASSESSMENT PLANS, CONDUCT CONTAMINATION ASSESSMENTS, PREPARE SITE ASSESSMENT REPORTS, REMEDIATION PLANS, IMPLEMENT REMEDIAL ACTION PLANS, RISK BASED CORRECTIVE ACTIONS, STORAGE TANKS SYSTEM REMOVAL, HIGHWAY SPILL RESPONSE AS WELL AS EXPERIENCE WITH INFRASTRUCTURE/CONSTRUCTION ACTIVITIES WITHIN (POTENTIALLY) CONTAMINATED AREAS SPECIFIC TO TRANSPORTATION SYSTEMS.

ALL THE WORK PERFORMED BY THE CAR CONTRACTOR SHALL BE PERFORMED IN COMPLIANCE WITH ALL APPLICABLE LOCAL STATE AND FEDERAL REGULATIONS GOVERNING WORKER SAFETY AND ENVIRONMENTAL REGULATIONS. THIS IS TO INCLUDE OCCUPATIONAL EXPOSURE TO CONTAMINATED SOILS, GROUNDWATER, WASTES AND ATMOSPHERE DURING THE CONSTRUCTION OF ALL FEATURES INCLUDED IN THE CONSTRUCTION PLANS. IN ADDITION, THE CAR CONTRACTOR MUST BE STAFFED WITH FLORIDA LICENSED TECHNICAL PROFESSIONALS (GEOLOGISTS AND ENGINEERS) WHO WILL BE INVOLVED WITH THE PROJECT AND KNOWLEDGEABLE OF THE WORK ACTIVITIES CONDUCTED WITHIN THE IDENTIFIED CONTAMINATED AREAS AND WHO WOULD SIGN AND SEAL PROJECT REPORTS AS REQUIRED FOR SUBMITTAL TO THE APPROPRIATE ENVIRONMENTAL REGULATORY AGENCIES.

THE LAP VILLAGE OF WELLINGTON ENGINEER WILL IMMEDIATELY NOTIFY THE FLORIDA DEPARTMENT OF TRANSPORTATION (FDOT) DISTRICT IV CONTAMINATION IMPACT COORDINATOR (CIC) AT (954) 777-4286 AFTER ENCOUNTERING THE UNIDENTIFIED AREAS OF CONTAMINATION. PRELIMINARY INVESTIGATION BY THE CAR CONTRACTOR WILL DETERMINE THE COURSE OF ACTION NECESSARY FOR THE PROJECT AND THE STEPS NECESSARY UNDER APPLICABLE LAWS, RULES, AND REGULATIONS FOR ADDITIONAL ASSESSMENT AND/OR REMEDIATION WORK TO RESOLVE THE CONTAMINATION ISSUE.

FOLLOWING COMPLETION OF THE PROJECT, THE CAR CONTRACTOR SHALL BE REQUIRED TO PROVIDE COPIES OF ALL REPORTS SUBMITTED TO REGULATORY AGENCIES, WASTE MATERIAL PROFILES, MANIFESTS AND/OR DISPOSAL RECEIPTS FOR HANDLING OF ALL CONTAMINATED MEDIA INCLUDING BUT NOT LIMITED TO GROUND WATER, WASTE WATER, SOILS, SOLID WASTES, SLUDGE, HAZARDOUS WASTES, AIR MONITORING RECORDS AND SAMPLE RESULTS FOR ALL MATERIALS TESTED AND ANALYZED TO THE LAP VILLAGE OF WELLINGTON ENGINEER AND THE FDOT DDC.

## LEGEND

### PROPOSED:

#### ASPHALT PAVEMENT

#### APPROACH SLAB

#### FINISHED GRADE ELEVATION

#### TRAFFIC SIGN

#### DRAINAGE FLOW ARROW

#### THREE RAIL WOOD FENCE

#### GUARDRAIL

#### DETECTABLE WARNING AT CURB RAMP

#### EXISTING:

#### MEASURED ELEVATION

#### SANITARY MANHOLE

#### DRAINAGE MANHOLE

#### CLEANOUT

#### FIRE HYDRANT

#### FENCE

#### GATE VALVE

#### WATER METER

#### CATCH BASIN

#### STREET LIGHT

#### TREE

#### INFORMATION SIGN

#### GUY WIRE

#### MAILBOX

#### ELECTRIC BOX

#### UTILITY POLE

#### BURIED ELECTRIC

#### BURIED TELEPHONE

#### OVERHEAD ELECTRIC

#### OVERHEAD TELEPHONE

#### STORM PIPE

#### GUARDRAIL

## ABBREVIATIONS

ELEV	ELEVATION
INV	INVERT
EXIST	EXISTING
FT	FEET
LF	LINEAR FEET
N.S.E.W	NORTH, SOUTH, EAST, WEST
R/W	RIGHT OF WAY
ORB	OFFICIAL RECORD BOOK
RF	REINFORCED CONCRETE PIPE
PB	PLAT BOOK
WM	WATERMAN
UT	UTILITY EASEMENT
AE	ACCESS EASEMENT
DE	DRAINAGE EASEMENT
CE	CENTERLINE
P	PROPERTY LINE
CAP	CORRUGATED ALUMINUM PIPE
PVC	POLYVINYL CHLORIDE
OD	OUTSIDE DIAMETER
OS	OFFSET
CY	CUBIC YARD
IN	INCH
LT	LEFT
RT	RIGHT
SF	SQUARE FEET
TOP	TOP OF PIPE
CRE	CURB
PC	POINT OF CURVATURE
PT	POINT OF TANGENCY
PI	POINT OF INTERSECTION
SY	SQUARE YARD
HDPE	HIGH DENSITY POLYETHYLENE
CMP	CORRUGATED METAL PIPE
TWB	TEMPORARY BENCHMARK
SES	FLARED END SECTION
C.W.E.	CONTROLLED WATER ELEVATION

## ENVIRONMENTAL

- PER CHAPTER 62-770, F.A.C., IF ANY HAZARDOUS MATERIAL IS FOUND ON THE PROJECT SITE, IT SHALL BE IMMEDIATELY REPORTED TO THE PROJECT MANAGER OR ENGINEER. THE APPROPRIATE REGULATORY AGENCY WILL BE CONTACTED IMMEDIATELY ALONG WITH IMMEDIATE RESTRICTED ACCESS TO THE PROJECT SITE. THE CONTRACTOR WILL THEN FOLLOW ORDERS GIVEN BY THE AUTHORITY IN AN INVESTIGATION AND/OR REMOVAL OF THE MATERIAL. THE CONTRACTOR IS RESTRICTED FROM RETURNING TO THE PROJECT SITE UNLESS AUTHORIZED TO DO SO.
- THE CONTRACTOR IS NOT PERMITTED TO TRANSPORT ANY HAZARDOUS MATERIAL ONTO THE PROJECT SITE AT ANYTIME UNLESS AUTHORIZED TO DO SO. IF THE CONTRACTOR WISHES TO TRANSPORT MATERIALS ONSITE TO PERFORM THE CONTRACTED WORK, THE CONTRACTOR MUST GET PERMISSION IN WRITING FROM THE PROJECT ENGINEER. THE CONTRACTOR WILL THEN PROVIDE A COPY OF THE MATERIAL SAFETY DATA SHEETS (MSDS) FOR EACH HAZARDOUS MATERIAL NEEDED TO CONTINUE THE PROPOSED WORK. A DESCRIPTION OF THE REASON OF USE MUST BE GIVEN ALONG WITH THE MSDS TO THE PROJECT ENGINEER WITH THE VILLAGE OF WELLINGTON BEFORE ISSUING A WRITTEN APPROVAL TO THE CONTRACTOR. STATE LAW DOES NOT CONSIDER PETROLEUM PRODUCTS THAT ARE PROPERLY CONTAINERIZED AS A HAZARDOUS MATERIALS. THEREFORE, THESE PRODUCTS DO NOT REQUIRE A MSDS SUBMITTAL. ALL BULK PETROLEUM PRODUCTS STORED ON SITE SHALL REQUIRE PROPER STORAGE AREAS WITH SECONDARY CONTAMINATION.
- THE CONTRACTOR SHALL COORDINATE SELECTION AND REVIEW OF ANY PROPOSED STAGING AREAS ASSOCIATED WITH THIS PROJECT WITH JONATHAN RENOVOLD, P.E. 561-791-4052 AT THE VILLAGE OF WELLINGTON. NO STAGING OF EQUIPMENT/VEHICLES WILL BE ALLOWED IN OR NEAR THE SFPMO STORMWATER MANAGEMENT AREAS AND THE WELLINGTON ENVIRONMENTAL PRESERVE.






Know what's below.  
Call before you dig.

NAVd88 + 1.437' = NGVD29

2025 Title Parkway Palm Beach, FL 33411 Phone No. 561.877.1110 Fax No. 561.877.1110 E-mail: info@811.com		REVISED		DATE		NO.		DESCRIPTION	
PROJECT: CAG 205903 BPP CIVIL PLANS.DWG		DRAWN: SOC		CHECKED: SOC		DATE: 8/7/77		SCALE: 1" = 50'	
ENGINEER OF RECORD: THOMAS WELLES, P.E.		DESIGNED: SOC		CHECKED: TM		DATE: 8/7/77		SCALE: 1" = 50'	
BINKS PROJECT PATHWAY FIM# 438306-158-01		GENERAL NOTES AND LEGENDS		C3		SHEET:		C3	





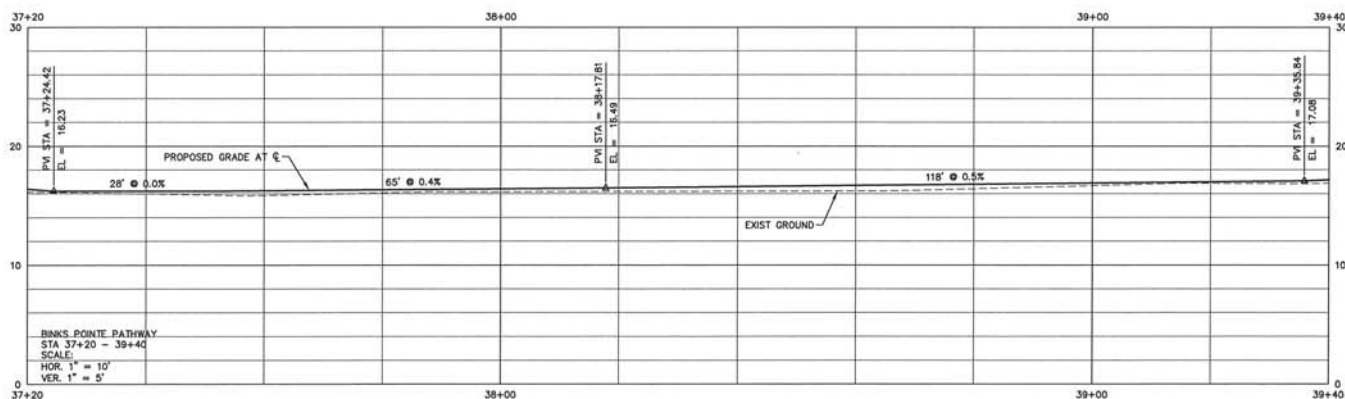
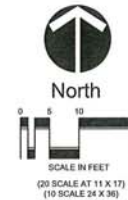
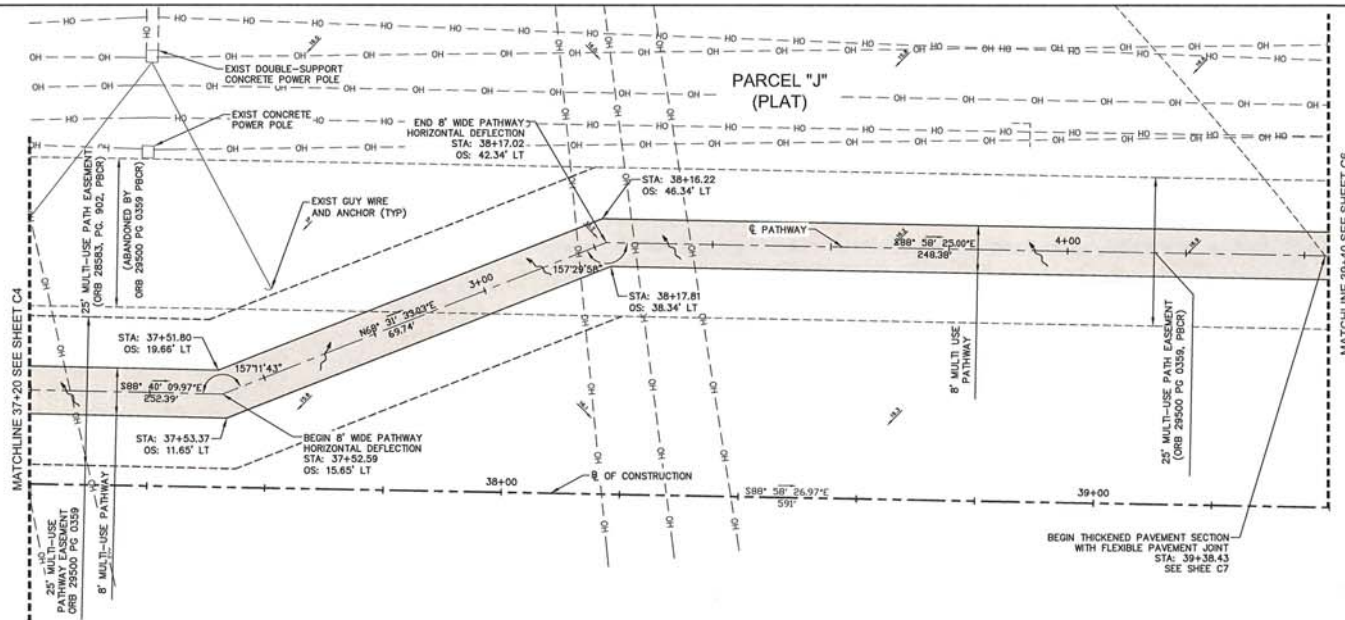


NAVD88 + 1.437' = NGVD29

PROJECT: BINKS POINT PATHWAY FPM# 438300-1-36-01 DATE: 8/7/17 SCALE: 1" = 10' SHEET: C5		REVISIONS NO. DATE DESCRIPTION 1 8/7/17 2 8/7/17 3 8/7/17 4 8/7/17 5 8/7/17 6 8/7/17 7 8/7/17 8 8/7/17 9 8/7/17 10 8/7/17 11 8/7/17 12 8/7/17 13 8/7/17 14 8/7/17 15 8/7/17 16 8/7/17 17 8/7/17 18 8/7/17 19 8/7/17 20 8/7/17 21 8/7/17 22 8/7/17 23 8/7/17 24 8/7/17 25 8/7/17 26 8/7/17 27 8/7/17 28 8/7/17 29 8/7/17 30 8/7/17 31 8/7/17 32 8/7/17 33 8/7/17 34 8/7/17 35 8/7/17 36 8/7/17 37 8/7/17 38 8/7/17 39 8/7/17 40 8/7/17 41 8/7/17 42 8/7/17 43 8/7/17 44 8/7/17 45 8/7/17 46 8/7/17 47 8/7/17 48 8/7/17 49 8/7/17 50 8/7/17 51 8/7/17 52 8/7/17 53 8/7/17 54 8/7/17 55 8/7/17 56 8/7/17 57 8/7/17 58 8/7/17 59 8/7/17 60 8/7/17 61 8/7/17 62 8/7/17 63 8/7/17 64 8/7/17 65 8/7/17 66 8/7/17 67 8/7/17 68 8/7/17 69 8/7/17 70 8/7/17 71 8/7/17 72 8/7/17 73 8/7/17 74 8/7/17 75 8/7/17 76 8/7/17 77 8/7/17 78 8/7/17 79 8/7/17 80 8/7/17 81 8/7/17 82 8/7/17 83 8/7/17 84 8/7/17 85 8/7/17 86 8/7/17 87 8/7/17 88 8/7/17 89 8/7/17 90 8/7/17 91 8/7/17 92 8/7/17 93 8/7/17 94 8/7/17 95 8/7/17 96 8/7/17 97 8/7/17 98 8/7/17 99 8/7/17 100 8/7/17		CHD 206903 BPP CIVIL PLANNING JOB NO. 2069.03 TOTAL SHEETS 9 DATE 8/7/17 SCALE 1" = 10' SHEET: C5	
--	--	---	--	--	--

2003 Vista Parkway  
 Suite 100  
 Brea, CA 92621  
 Phone No. 949.897.2200  
 Fax No. 949.897.1110  
 E-mail: info@wgi.com  
 Web: www.wgi.com



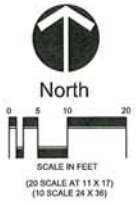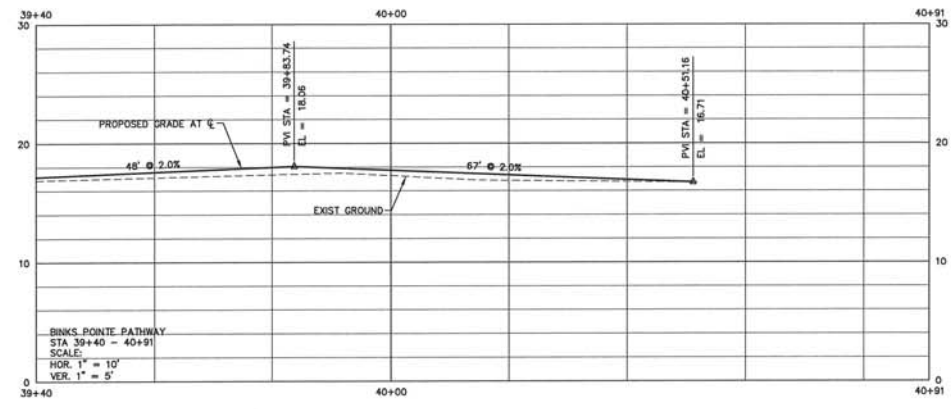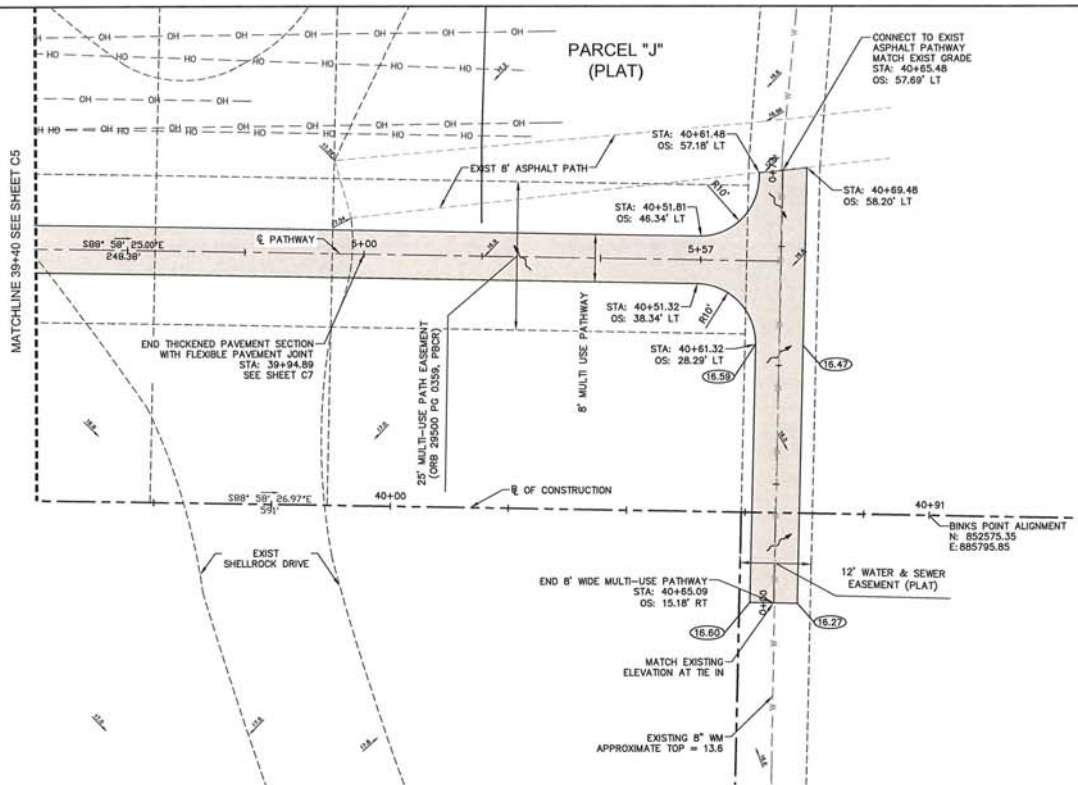

PROJECT: BINKS POINT PATHWAY FM# 438306-1-58-01		SHEET: C6	
TITLE: PLAN AND PROFILE		DATE: 8/1/17	
DRAWN: THOMAS MUELLER PE		CHECKED: TM	
JOB NO.: 2009.03		SCALE: 1" = 10'	
TOTAL SHEETS: 9		DATE: 8/1/17	
CAD 200903 BPP CIVIL PLANS.DWG		NO. DATE	
REVISIONS		DESCRIPTION	
1		1	

2025 Vista Parkway  
 Suite 100  
 Fort Worth, TX 76111  
 Phone No. 817.687.2220  
 Fax No. 817.687.2220  
 Email: info@811.com  
 Web: www.811.com







PROJECT: BINKS POINT PATHWAY FM# 438306-1-58-01		SHEET: C6	
TITLE: PLAN AND PROFILE		DATE: 8/1/17	
DRAWN: THOMAS MUELLER PE		CHECKED: TM	
JOB NO.: 2009.03		SCALE: 1" = 10'	
TOTAL SHEETS: 9		DATE: 8/1/17	
CAD 200903 BPP CIVIL PLANS.DWG		NO. DATE	
REVISIONS		DESCRIPTION	
1		1	

NAVD88 + 1.437' = NGVD29





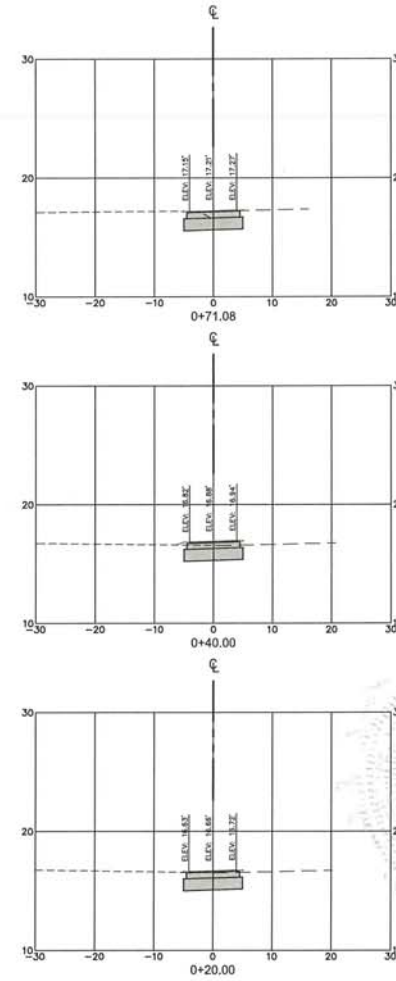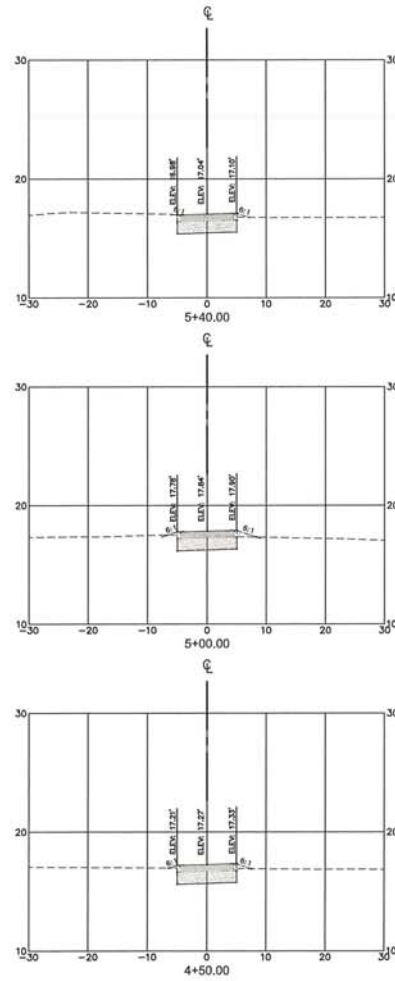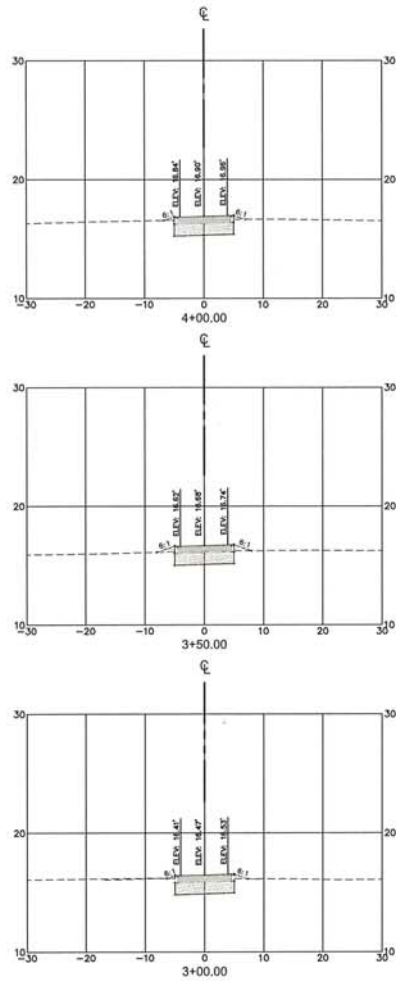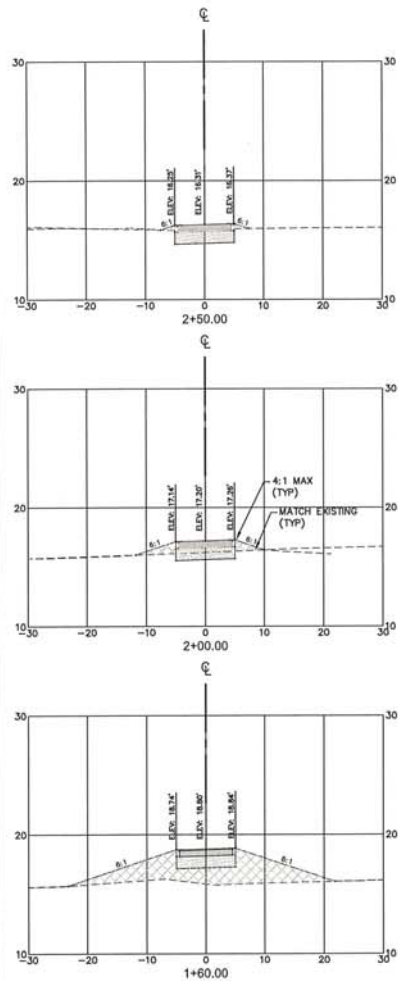



NAVD88 + 1.437' = NGVD29

<b>PROJECT:</b> BINKS PATHWAY FM# 438306-158-01 YEAR: 2008		<b>ENGINEER OF RECORD:</b> THOMAS MUELLER, PE PLS 0115		<b>DATE:</b> 8/7/17 <b>SCALE:</b> N/A		<b>DESIGNED:</b> TM <b>CHECKED:</b> OC <b>BY:</b> BNO		<b>REVISIONS:</b> <table border="1"> <thead> <tr> <th>NO.</th> <th>DATE</th> <th>DESCRIPTION</th> </tr> </thead> <tbody> <tr> <td>1</td> <td></td> <td></td> </tr> </tbody> </table>		NO.	DATE	DESCRIPTION	1		
NO.	DATE	DESCRIPTION													
1															
<b>2008 Vista Parkway</b> Station 0+00.00 to 0+71.08 Plan No. 44.487.2320 File No. 44.487.1110 Cont No. 6091 - L&P No. 7045															



**SHEET:**  
C8




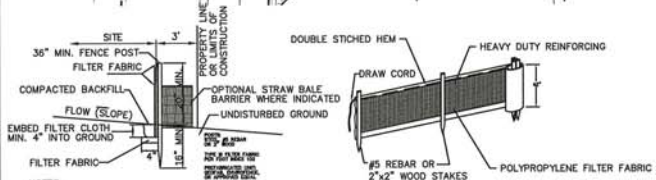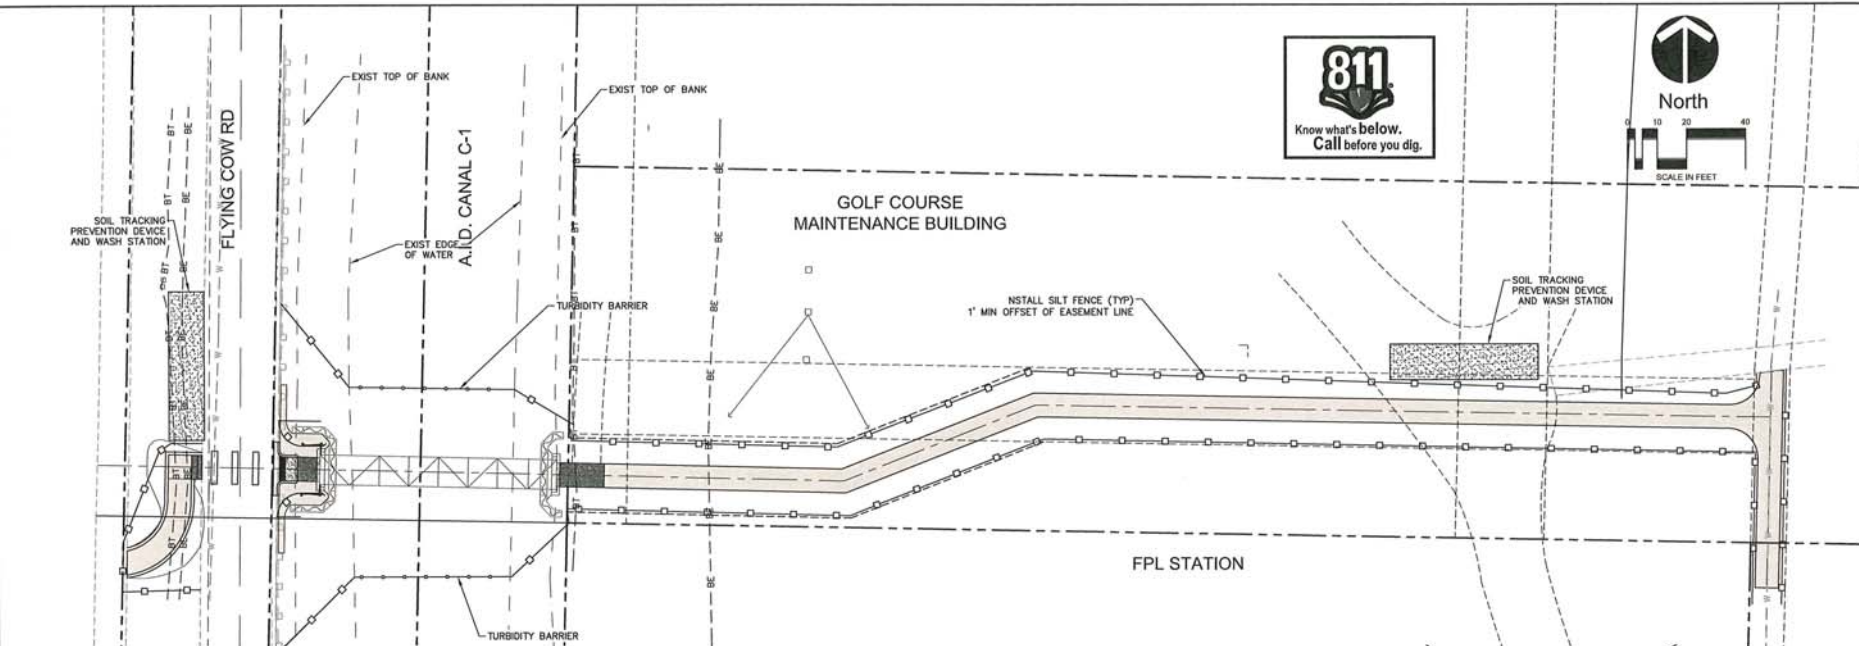

- NOTES:
1. FILTER FABRIC FENCE TO BE FASTENED SECURELY TO FENCE POSTS WITH WIRE TIES OR STAPLES SPACED EVERY 24\"/>
  2. WHEN TWO SECTIONS OF FILTER CLOTH ADJOIN EACH OTHER, THEY SHALL BE OVERLAPPED BY SIX INCHES AND FOLDED.
  3. MAINTENANCE SHALL BE PERFORMED AS NEEDED AND MATERIAL REMOVED WHEN "BULGES" DEVELOP IN THE SILT FENCE OR DEPTH OF ACCUMULATED SEDIMENT REACHES 6 INCHES.
  4. SILT FENCE SHALL BE INSTALLED PER MANUFACTURERS SPECIFICATIONS PRIOR TO THE START OF CONSTRUCTION AND SHALL NOT BE REMOVED UNTIL CONSTRUCTION IS COMPLETE.
  5. THE CONTRACTOR SHALL INSPECT AND REPAIR THE SILT FENCE AFTER EACH RAIN EVENT AND REMOVE SEDIMENT WHEN NECESSARY.
  6. REMOVED SEDIMENT SHALL BE DEPOSITED IN AN AREA THAT WILL NOT CONTIBUTE SEDIMENT OFFSITE AND CAN BE PERMANENTLY STABILIZED.
  7. THE SILT FENCE SHALL BE PLACED ON SLOPE CONTOUR TO MAXIMIZE ITS PONDING EFFICIENCY.
  8. IF DITCH LEVEL IS DEEPER THAN 30\", THEN A FLOATING SILT SCREEN SHALL BE USED.

#### SILT FENCE INSTALLATION


SCALE: NONE

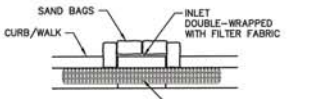

- NOTES:
1. CURB INLET SOCK SHALL NOT BE ABOVE THE SIDEWALK IF OPEN TO PEDESTRIANS.

#### CURB INLET PROTECTION


SCALE: NONE

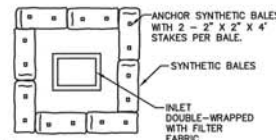

- NOTES:
1. BALES SHALL BE USED AROUND ALL INLETS UNTIL ROAD BASE AND CURBS ARE COMPLETE.
  2. BALES SHALL REMAIN AROUND DITCH INLETS UNTIL FINAL STABILIZATION.

#### DITCH/PAVEMENT INLET PROTECTION


SCALE: NONE

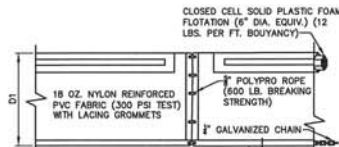

- NOTES:
1. TURBIDITY BARRIERS ARE TO BE USED IN ALL PERMANENT BODIES OF WATER REGARDLESS OF WATER DEPTH.
  2. NUMBER AND SPACING OF ANCHORS DEPENDANT ON CURRENT VELOCITIES.
  3. DEPLOYMENT OF BARRIER AROUND PILE LOCATIONS MAY VARY TO ACCOMMODATE CONSTRUCTION OPERATIONS.
  4. NAVIGATION MAY REQUIRE SEGMENTING BARRIER DURING CONSTRUCTION OPERATIONS.
  5. FOR ADDITIONAL INFORMATION SEE SECTION 104 OF THE STANDARD SPECIFICATIONS.
  6. FOR ADDITIONAL DETAILS SEE FDOT INDEX NO. 103.

#### FLOATING TURBIDITY BARRIER

N.T.S.

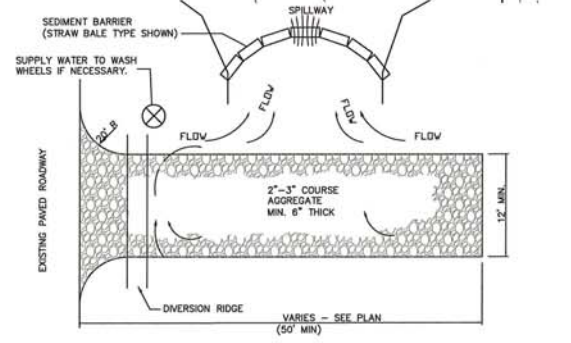

- NOTES:
1. THE ENTRANCE SHALL BE MAINTAINED IN A CONDITION THAT WILL PREVENT TRACKING OR FLOWING OF SEDIMENT ONTO PUBLIC RIGHTS-OF-WAY. THIS MAY REQUIRE TOP DRESSING, REPAIR AND/OR CLEANOUT OF ANY MEASURES USED TO TRAP SEDIMENT.
  2. WHEN NECESSARY, WHEELS SHALL BE CLEANED PRIOR TO ENTRANCE ONTO PUBLIC RIGHT-OF-WAY.
  3. WHEN WASHING IS REQUIRED, IT SHALL BE DONE ON AN AREA STABILIZED WITH CRUSHED STONE THAT DRAINS INTO AN APPROVED SEDIMENT TRAP OR SEDIMENT BASIN.

#### SOIL TRACKING PREVENTION DEVICE

SCALE: NONE

205903 BPP CIVIL PLANS INC.		DATE	NO.	DESCRIPTION
CAD	2008.03	9/1/17	9	DESIGNED SCC
DESIGNED	9/1/17	9/1/17	9	CHECKED TM
SCALE	1" = 20'	LOC	BNO	
BINKS POINT PATHWAY FIM# 438306-1-58-01				
STORMWATER POLLUTION PREVENTION PLAN				
SHEET: C9				

2035 Vista Parkway  
West Palm Beach, FL 33411  
Phone No. 561.687.2120  
Fax No. 561.687.1110  
Cert No. 6691 - L.D. No. 7035



PROJECT:		BINKS POINT PEDESTRIAN BRIDGE		CADD		REVISONS	
SHEET:		PREFABRICATED PEDESTRIAN BRIDGE PLAN		2019.03		DATE	
S1.0		P.E. # 5096		2019.03		DATE	
				DESIGNED T/JW		DESCRIPTION	
				DATE 8/1/77		CHECKED CBL	
				SCALE AS SHOWN		BGR	







PILE DATA TABLE																		TABLE DATE 12-15-17	
INSTALLATION CRITERIA									DESIGN CRITERIA									PILE CUT-OFF ELEVATIONS	
PIER OR BENT NUMBER	PILE NUMBERS	PILE SIZE (in.)	NOMINAL BEARING RESISTANCE (tons)	NOMINAL UPLIFT RESISTANCE (tons)	MINIMUM TIP ELEVATION (ft.)	TEST PILE LENGTH (ft.)	REQUIRED JET ELEVATION (ft.)	REQUIRED PREFORM ELEVATION (ft.)	FACTORED DESIGN LOAD (tons)	FACTORED DESIGN UPLIFT LOAD (Tons)	DOWN DRAG (tons)	TOTAL SCOUR RESISTANCE (tons)	NET SCOUR RESISTANCE (tons)	100-YEAR SCOUR ELEVATION (ft.)	LONG TERM SCOUR ELEVATION (ft.)	Ø COMPRESSION	Ø UPLIFT	END BENT NO. 1	END BENT NO. 2
1	1 - 2	14	39	N/A	(-)5.44	-	N/A	N/A	25	N/A	0	N/A	N/A	N/A	N/A	0.65	0.65	15.56	
2	3	14	39	N/A	(-)5.44	40	N/A	N/A	25	N/A	0	N/A	N/A	N/A	N/A	0.65	0.65		15.56
2	4	14	39	N/A	(-)5.44	-	N/A	N/A	25	N/A	0	N/A	N/A	N/A	N/A	0.65	0.65		15.56

$$\frac{\text{Factored Design Load} + \text{Net Scour Resistance} + \text{Down Drag}}{\phi} \leq \text{Nominal Bearing Resistance}$$

**TENSION RESISTANCE -** The ultimate side friction capacity that must be obtained below the 100 year scour elevation to resist pullout of the pile (Specify only when design requires tension capacity).

**TOTAL SCOUR RESISTANCE -** An estimate of the ultimate static side friction resistance provided by the scourable soil.

**NET SCOUR RESISTANCE -** An estimate of the ultimate static side friction resistance provided by the soil from the required preformed or jetting elevation to the scour elevation.

**100-YEAR SCOUR ELEVATION -** Estimated elevation of scour due to the 100 year storm event.

#### PILE INSTALLATION NOTES:

Contractor to verify location of all utilities prior to any pile installation activities. Coordinate pile driving schedule with Village of Wellington inspector. Minimum Tip Elevation is required for lateral stability.

When a required jetting elevation is shown, the jet shall be lowered to the elevation and continue to operate at this elevation until the pile driving is completed. If jetting or preforming elevations differ from those shown on the table, the Engineer shall be responsible for determination of the required driving resistance.

No jetting will be allowed without the approval of the Engineer.

The Contractor should not anticipate being allowed to jet piles below the 100-year scour elevation or required jet elevation.

At each Bent, pile driving is to commence at the center of the Bent and proceed outward.

See construction specifications for additional requirements.


Service Pile Load = 19 Tons

Production Piles Estimated at 25 feet.

Test pile may be cut off once nominal bearing resistance and minimum tip elevation are both achieved.



1000 West Parkway Wellington, FL 33411 Phone No. 561.877.2299 Fax No. 561.877.2299 E-mail: info@wgi.com Web: www.wgi.com	
PROJECT BINKS POINTE PEDESTRIAN BRIDGE	SHEET: S1.2
DATE 4/19/18	SCALE AS SHOWN
DRAWN DAM	CHECKED ORL
DESIGNED TAW	BOR
TOTAL SHEETS 12	DATE 4/19/18
LAD 2009.03	SCALE AS SHOWN
ENGINEER OF RECORD P.E. # 65906	SCALE AS SHOWN

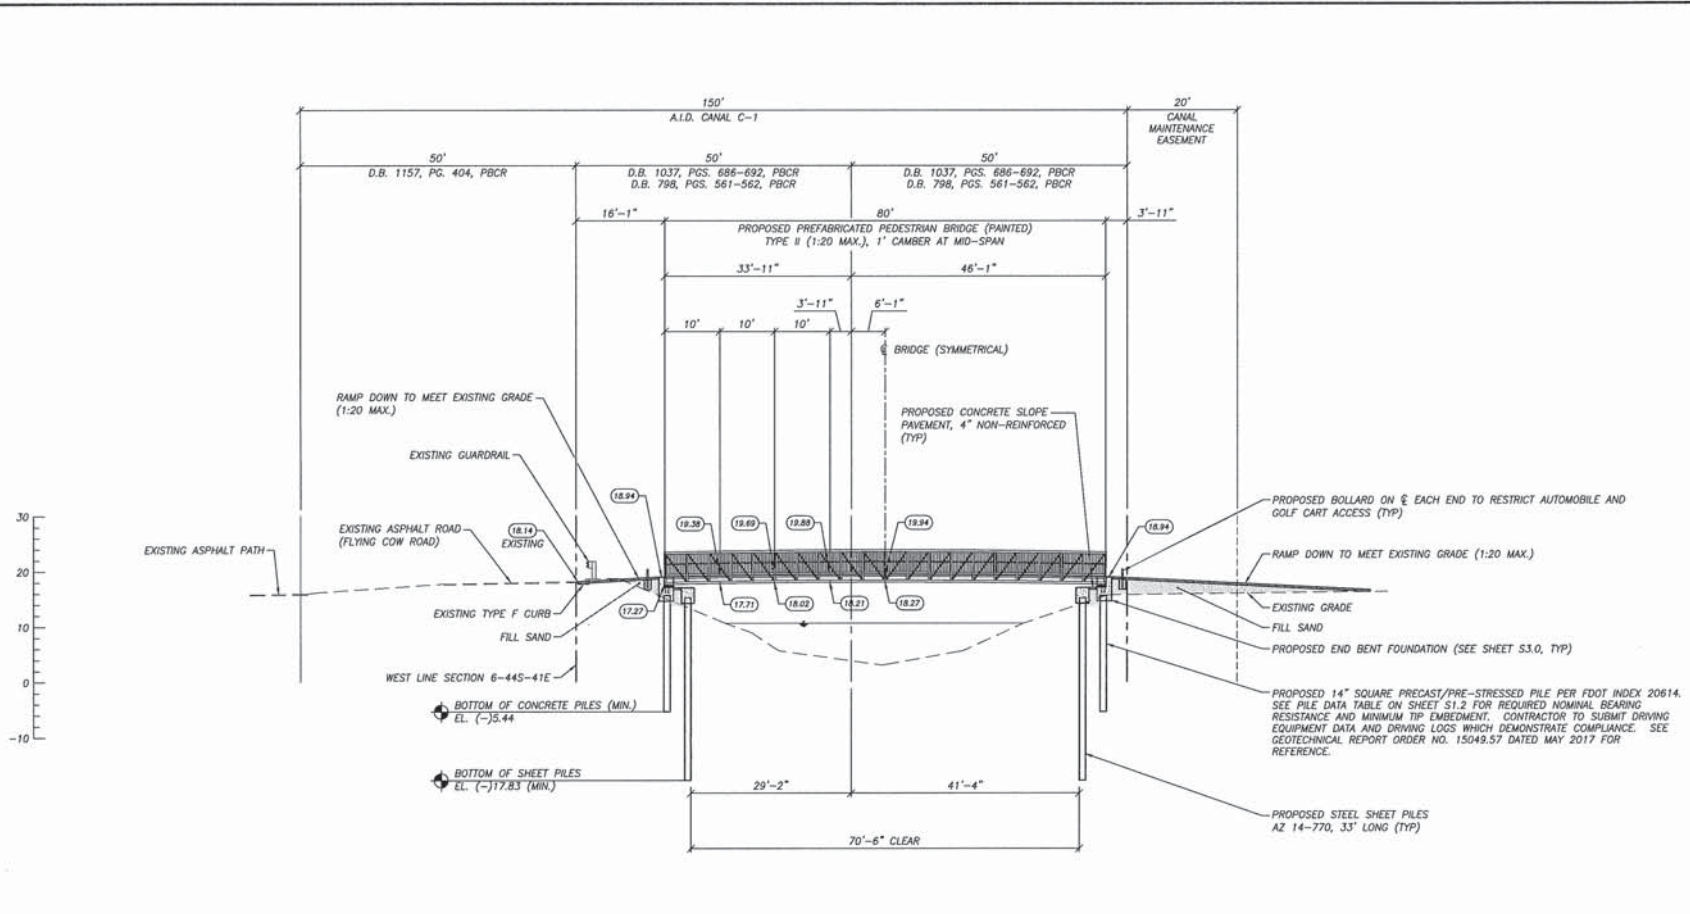


1 PREFABRICATED PEDESTRIAN BRIDGE ELEVATION

GRAPHIC SCALE IN FEET




WGI 1000 N. Pine Street Suite 100 Palm Beach, FL 33411 Phone: 561.887.2220 Fax: 561.887.2221 Email: info@wgi.com		REVISIONS NO. DATE DESCRIPTION 1 1/19/18		CAD JOB NO. 2009.03 TOTAL SHEETS 12 DATE 8/1/17 SCALE AS SHOWN		PROJECT BINKS POINTE PEDESTRIAN BRIDGE PRE-FABRICATED PEDESTRIAN BRIDGE ELEVATION		SHEET: S2.0
DRAWN DESIGNED CHECKED IN CHARGE		DAM 12 12 12 12		PRODUCTION PHASE 4/19/18				

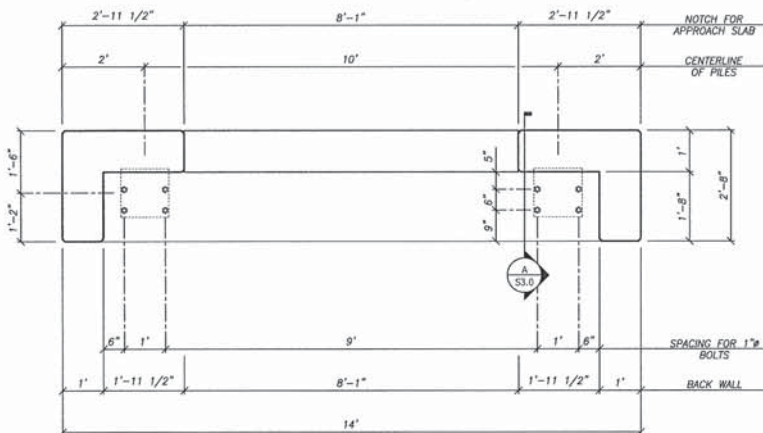


1 END BENT PLAN  
(FOR WEST END)

GRAPHIC SCALE IN FEET

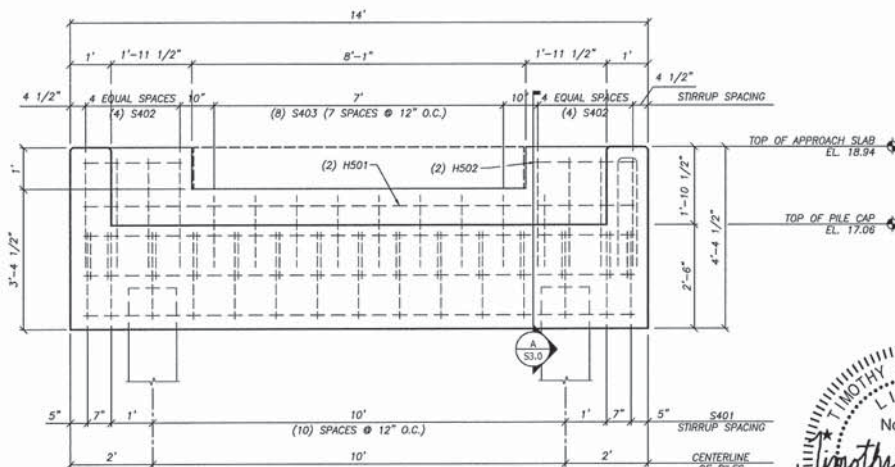

2 END BENT ELEVATION

GRAPHIC SCALE IN FEET

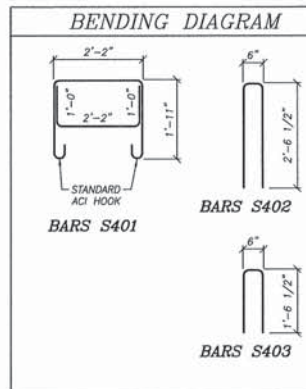


# ESTIMATED END BENT QUANTITIES

ITEM	UNIT	QUANTITY
CLASS II CONCRETE (END BENT PILE CAP)	CU. YDS.	5
REINFORCING STEEL (END BENT PILE CAP)	LBS.	499

## BILL OF REINFORCING STEEL


MARK	SIZE	NUMBER REQUIRED	TOTAL LENGTH	BENDING	WEIGHT (LBS.)
		END BENT (1 EACH)			
H501	#5	2	13'-4"	STRAIGHT	28
H502	#5	2	2'-4 1/2"	STRAIGHT	5
T801	#8	3	13'-4"	STRAIGHT	107
M802	#8	3	13'-4"	STRAIGHT	107
B803	#8	2	13'-4"	STRAIGHT	71
S401	#4	16	10'-6"	BARS S401	112
S402	#4	12	6'-0"	BARS S402	48
S403	#4	8	4'-0"	BARS S403	21

ALL CONCRETE MIN.  $f'_c = 4,000$  PSI @ 28 DAYS.  
ALL REINFORCING STEEL ASTM A615 OR 60.  
SEE CONSTRUCTION SPECIFICATIONS FOR ADDITIONAL REQUIREMENTS.

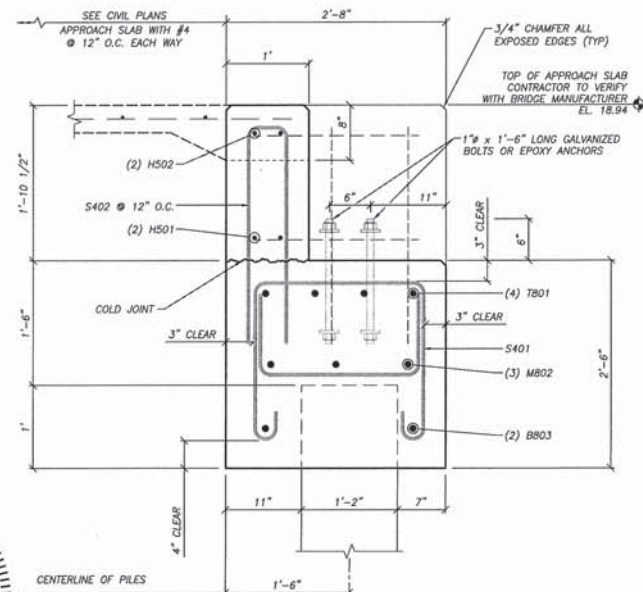

3 SECTION A - A

GRAPHIC SCALE IN FEET

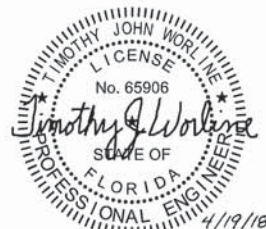

4/19/18

PRODUCTION PHASE

PROJECT

BINKS POINTE  
PEDESTRIAN BRIDGE  
PREFABRICATED PEDESTRIAN  
BRIDGE DETAILS

SHEET:  
S3.0

DATE: 8/1/17

SCALE: AS SHOWN

DESIGNED BY: J. W. W.

CHECKED BY: J. W. W.

APPROVED BY: J. W. W.

REVISIONS

NO. DATE DESCRIPTION

1 10/1/17

2 10/1/17

3 10/1/17

4 10/1/17

5 10/1/17

6 10/1/17

7 10/1/17

8 10/1/17

9 10/1/17

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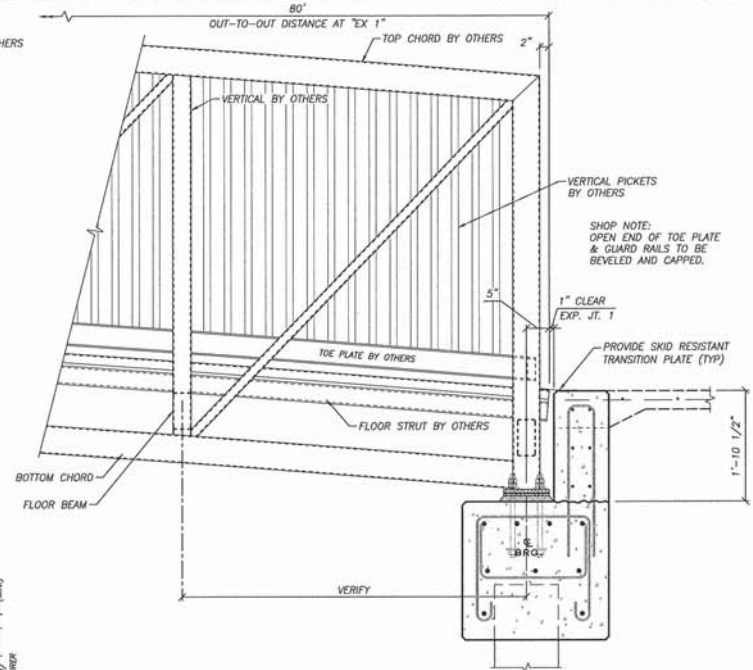
97 10/1/17

98 10/1/17

99 10/1/17

100 10/1/17





ANCHOR BOLT 1"ø x 1'-6" MIN. (TYP)

1 1/4" x 2 1/2" SLOTTED HOLE

BEARING PLATE (SHOP WELDED TO BRIDGE)

TEFLON PAD (SHIPPED LOOSE)

SETTING PLATE (SHIPPED LOOSE)

1 1/4"ø HOLE

DOUBLE NUT W/ WASHER TO ALLOW MOVEMENT, TIGHTEN BOTTOM NUT, LOOSEN 1/4 TURN AND TIGHTEN TOP NUT TO BOTTOM NUT.

± 1 1/4" GROUT BED

EL. 17.27

TRUSS BEARING  
EL. 17.27

80'-2"

79'-2"

6"

(VERIFY WITH MANUFACTURER)  
DISTANCE FROM CENTER TO CENTER OF BEARING

6"

DOUBLE NUT W/ WASHER TO ALLOW  
MOVEMENT, TIGHTEN BOTTOM NUT, LOOSEN  
1/4 TURN AND TIGHTEN TOP NUT TO  
BOTTOM NUT.

1'-10 1/2"

1'-1"

6"

1 1/4"

GROUT

ANCHOR BOLTS

6 ABUTMENT LAYOUT SECTION  
S3.1 NOT TO SCALE

**SHEET: S3.1**

**PROJECT:** BANKS POINT PEDESTRIAN BRIDGE

**DATE:** 8/17/77

**BY:** J. W. MORRIS, P.E.


**SCALE:** AS SHOWN

**REVISIONS:**

NO.	DATE	BY
1	8/17/77	J. W. MORRIS

**2025 Visa Parkway**  
**West Palm Beach, FL 33411**  
**Phone: (407) 833-1111**  
**Fax: (407) 833-1111**  
**Circle 101 on Reader Service Card**

**WGL**

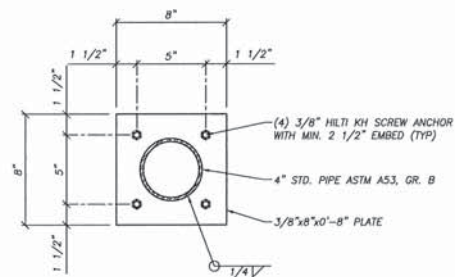


3  
S3.2

PROPOSED BOLLARD BASE PLATE SECTION


0.5 0.25 0 1

GRAPHIC SCALE IN FEET

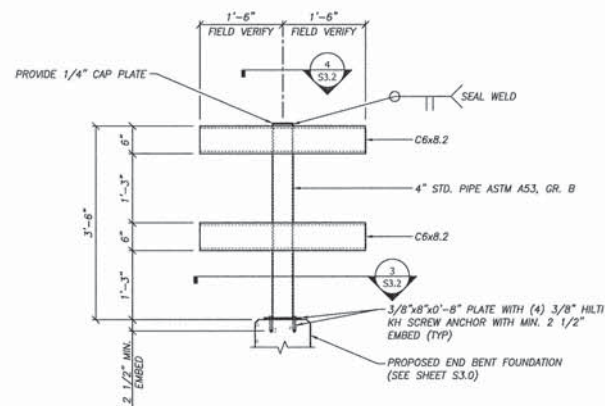

**NOTE:**  
BOLLARD AND RAILING ASSEMBLY TO BE PAINTED. FOLLOW  
PAINT SPECIFICATION FOR BRIDGE AND MATCH COLOR.


1 0.5 0 1  
GRAPHIC SCALE IN FEET

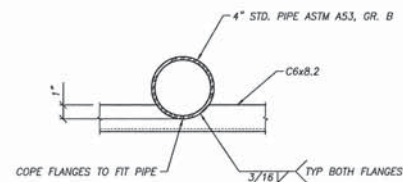

4 PROPOSED BOLLARD & RAILING SECTION  
53.2  
0.5 0.25 0 1  
GRAPHIC SCALE IN FEET



PRODUCTION PHASE		PROJECT		EMPLOYER OF RECORD		CADD		REVISOR		DATE		REV	
SHEET: S3.2		BINKS POINT PEDESTRIAN BRIDGE		P.E. # 16096		JOHN NO. 2008.03		SMAVAN		04/11/2008		87	
PREFABRICATED PEDESTRIAN BRIDGE DETAIL S.						TOTAL SHEETS 12		DESIGNED JAM					
						DATE 5/17/07		DESIGNED DCL					

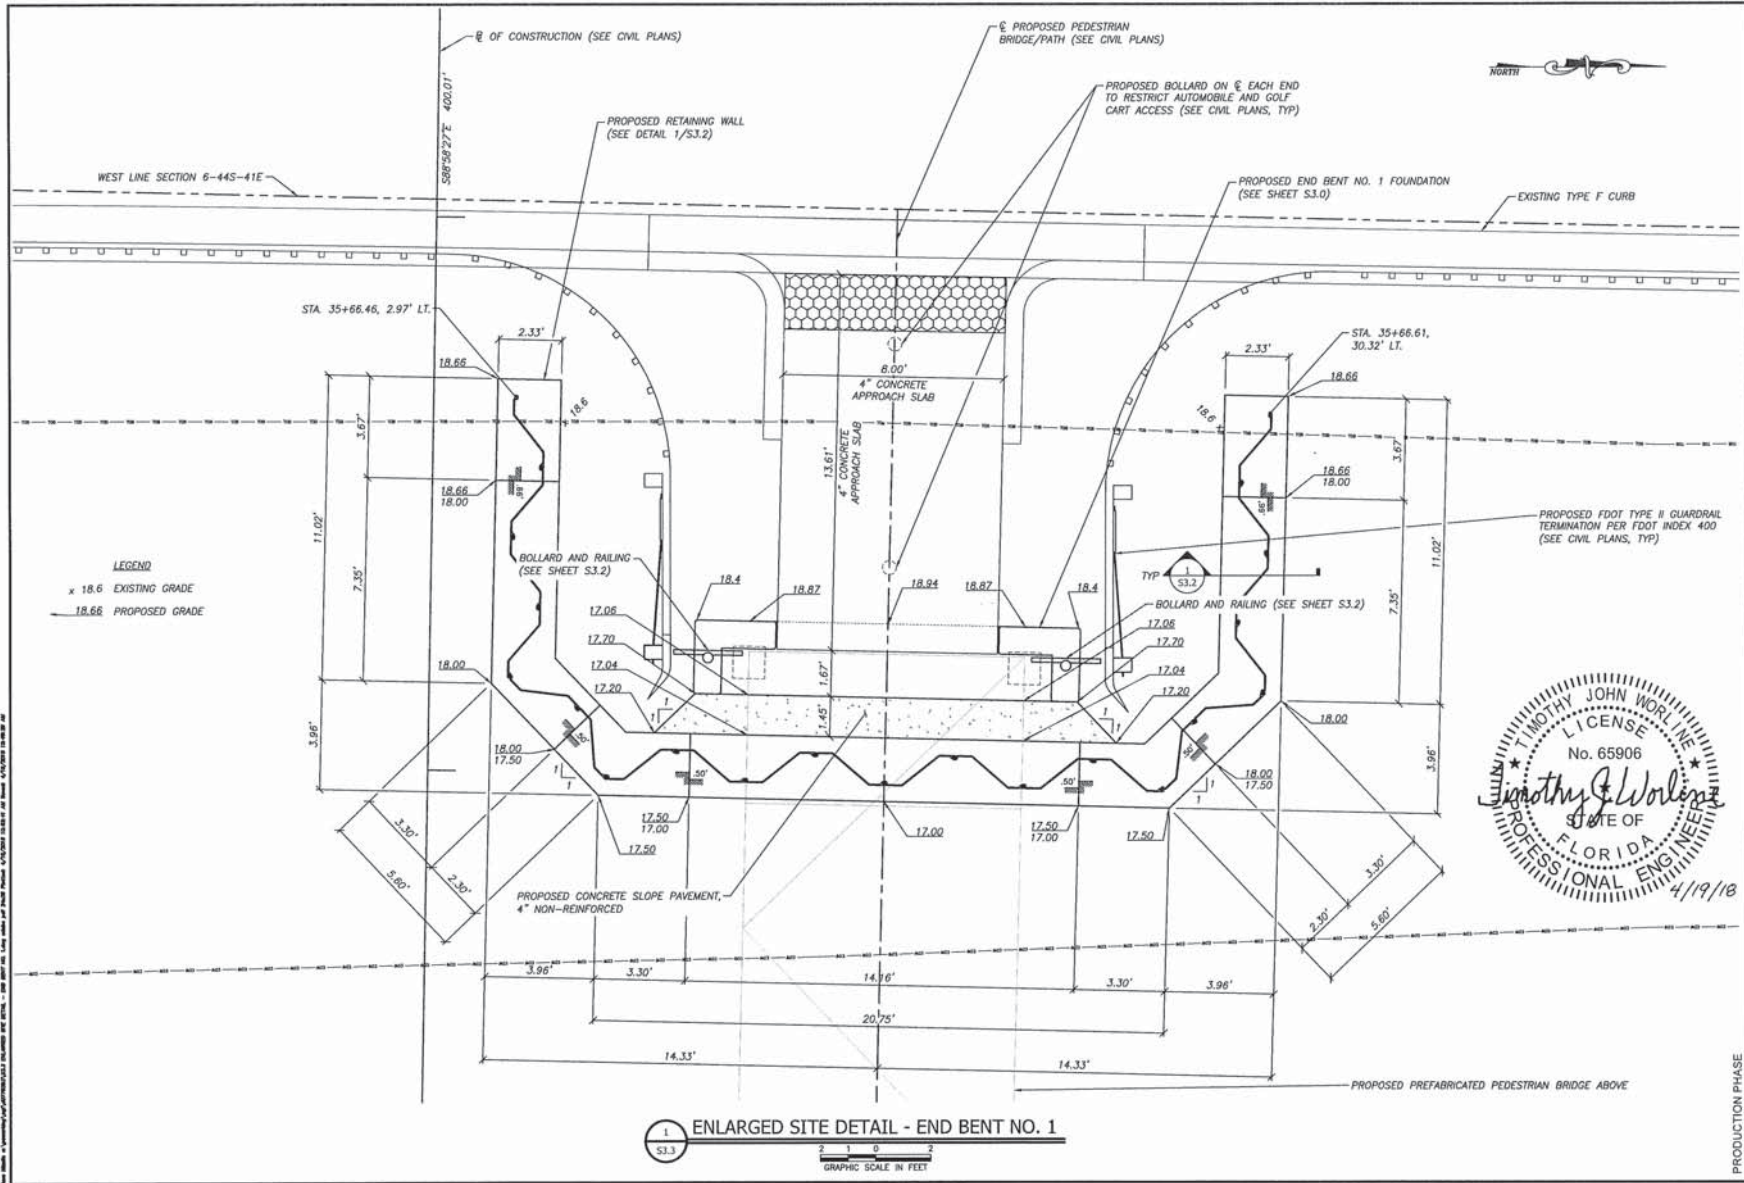

1  
S3.3

ENLARGED SITE DETAIL - END BENT NO. 1


GRAPHIC SCALE IN FEET




SHEET:		BINKS POINTE PEDESTRIAN BRIDGE		DRAWN BY THOMAS J. WILSON, P.E. P.E. # 6886		DATE 2009.03		SHEET NO. 12		DWG NO. 2009.03		PROJECT NO. 2009.03		REV.		DATE		DESCRIPTION	
S3.3		ENLARGED SITE DETAIL - END BENT NO. 1																	





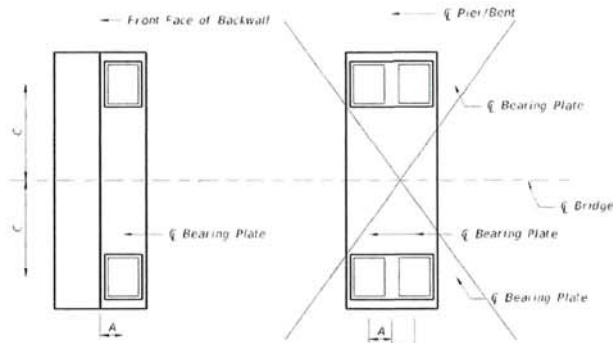


TYPICAL END BENT TYPICAL INTERMEDIATE PIER/BENT  
PARTIAL PLAN

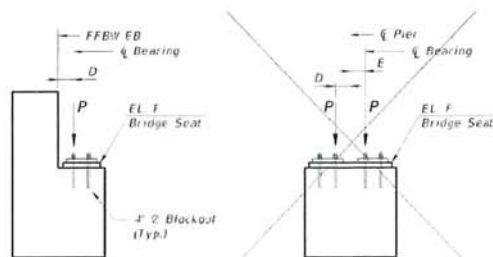

TYPICAL END BENT TYPICAL INTERMEDIATE PIER/BENT  
PARTIAL ELEVATION

BEARING LOCATIONS & BRIDGE SEAT ELEVATIONS						
BENT/ PIER	A (in.)	B (in.)	C (ft.)	D (in.)	E (in.)	F (ft.)
1	6.75	NA	5'-0"	35	NA	16.61
2						
3						
4						
5						

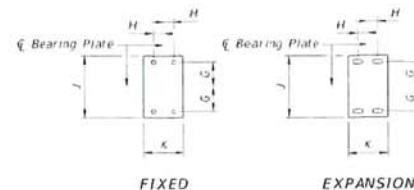

BEARING PLATE DETAILS

BEARING PLATE DIMENSIONS				
SPAN	G (in.)	H (in.)	J (in.)	K (in.)
1	6	3	15.5	11.5
2				
3				
4				

COMPANY CONTACT INFORMATION	
COMPANY	CONTECH ENGINEERING SOLUTIONS
ADDRESS	8301 STATE HIGHWAY 29 NORTH ALEXANDRIA, NV 86308
CONTACT	LEE HANSON
PHONE	513-645-7738
E-MAIL	LHANSON@CONTECHES.COM

BRIDGE REACTIONS			
	SPAN 1		
	P (kips)	T (kips)	L (kips)
DEAD LOAD	14.0		
UNFACTORED LIVE LOAD	18.6		
VEHICLE LOAD	2.0		
WIND UPLIFT	WINDWARD	6.7	
	LEEWARD	2.3	
WIND <sup>2</sup>	TRANSVERSE	12.5	
	VERTICAL 1 <sup>1</sup>	5.2	
THERMAL			2.0

1. P - Unfactored Vertical Load each Bearing Plate (4 per Span)  
T - Unfactored Transverse Load each Bent/Pier (2 per Span)  
L - Unfactored Longitudinal load each Bearing Plate (4 per Span)
2. Downward vertical loads are positive (+), upward vertical loads are negative (-).
3. The horizontal wind load acting at the c.g. of the truss creates a transverse shear and a vertical couple at the top of each pier/bearing location.
4. Design Specifications
  - FDOT Structures Manual, current Edition and supplements thereto
  - American Association of State Highway and Transportation Officials (AASHTO) Load and Resistance Factor (LRFD) Bridge Design Specifications, current Edition and supplements thereto
  - AASHTO LRFD Guide Specifications for the Design of Pedestrian Bridges, current Edition
  - FDOT Plans Preparation Manual, current Edition
5. Construction Specifications
  - FDOT Standard Specifications for Road and Bridge Construction, current Edition and supplements thereto

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PRODUCTION PHASE

PROJECT

BINKS POINTE  
PEDESTRIAN BRIDGE  
CONTECH PEDESTRIAN BRIDGE  
DATA SHEET

SHEET:  
BP-1

REVISIONS

NO.	DATE	DESCRIPTION
1		
2		
3		
4		
5		

DATE	DESIGNED	CHECKED	SCALE	DATE	SCALE
2006.03	12	8/1/07	AS SHOWN		

SCALE

SCALE

SCALE

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