

Cotleur

Hearing

Landscape Architecture **Environmental Consulting** Graphic Design

1934 Commerce Lane Jupiter, Florida 33458 561-747-6336 Fax-747-1377


6.64%

6.55%

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Unit Type	Type I	Type I.1	Type II.1	Type II.2	Type III.1	Type II.2	Type V.1	1-15/2
lo. of Stories	3	2	3*	3	3*	3	3	
No. of Bldgs	8	1	7	3	5	8	1	Totals
	(12 Units /Bldg)	(8 Units /Bldg)	(8 Units /Bldg)	(8 Units /Bldg)	(12 Units /Bldg)	(12 Units /Bldg)	(10 Units /Bldg)	
A - 1 BR	96	8	0	0	0	0	0	104
B-2BR	0	. 0	14	6	20	32	3 .	75
BE - 2 BR	0	0	14	6	10	16	2	48
C-2BR	0	0	14	0	10	0	2 .	26
D-3BR	0	0	14	6	20	32	3 '	' 75
E-4BR	0	0	0 -	6	0	16	0	22
otals	96	8	56	24	60	96	10	350

VILLAGE OF WELLINGTON PETITION NO. 18-37 (20/8-/3 WASA1) P&Z PROJECT MANAGER: D.NEWELL

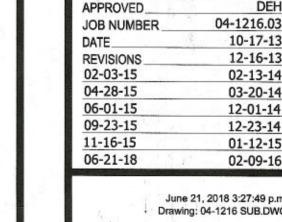



DESIGNED.

DRAWN\_

Drawing: 04-1216 SUB.DW0

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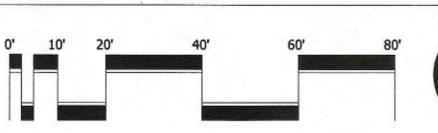


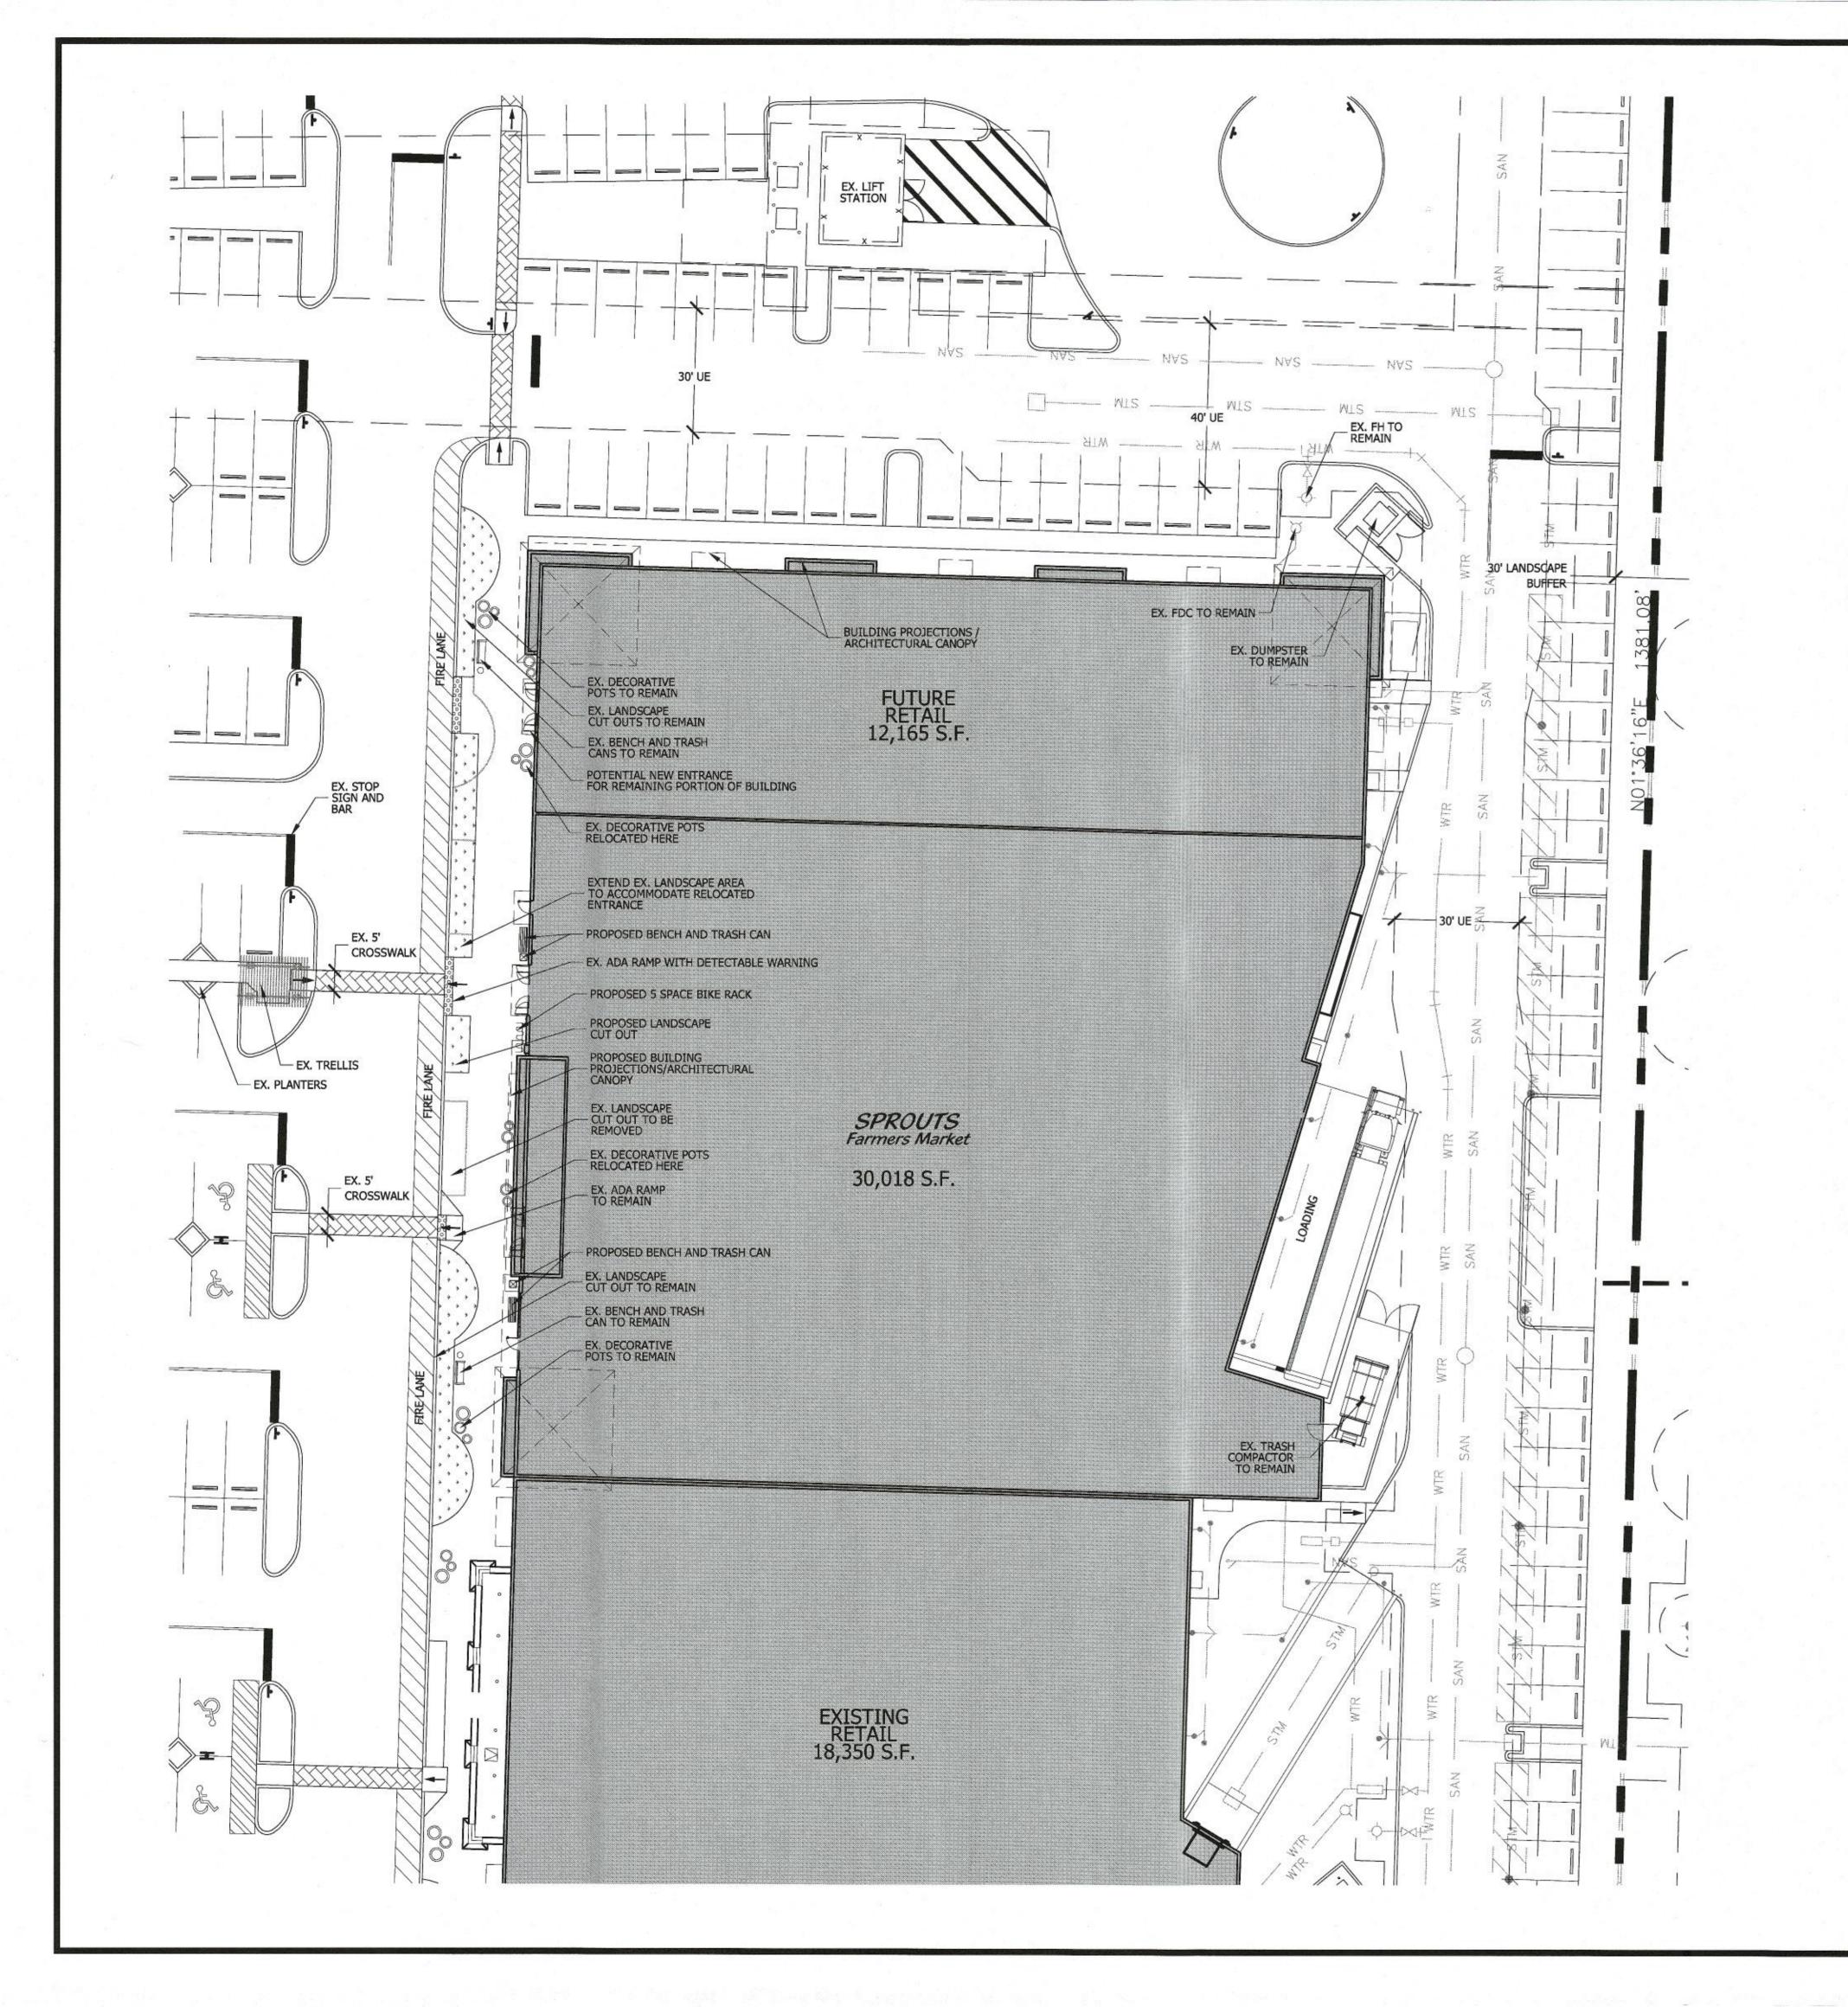

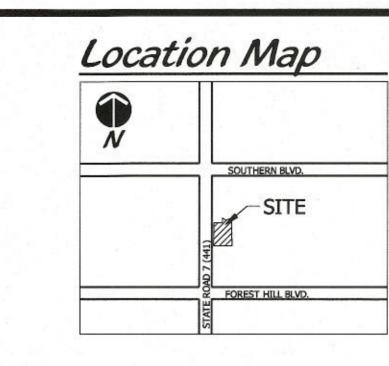

VILLAGE OF WELLINGTON
PETITION NO. 18-37(2018-13WASAZ)
APPROVED LATE: JUNE 28,2018
P&Z PROJECT MANAGER: NEWELL
SPIAT, SPIATI AND LPIOFI

Site Plan



Scale: 1" = 20'-0"



North

a Verde Commercial

Cotleur

Hearing

Landscape Architecture
Planning
Environmental Consulting

1934 Commerce Lane

Jupiter, Florida 33458 561-747-6336 Fax-747-1377


Graphic Design

ESIGNED	DEH
RAWN	RO
PPROVED	DEH
OB NUMBER	04-1216.04
ATE	04-25-18
EVISIONS	06-06-18
	06-21-18

June 21, 2018 3:27:49 p.m. Drawing: 04-1216 SUB.DWG

SHEET 1 OF 1

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Planning
Environmental Consulting
Graphic Design

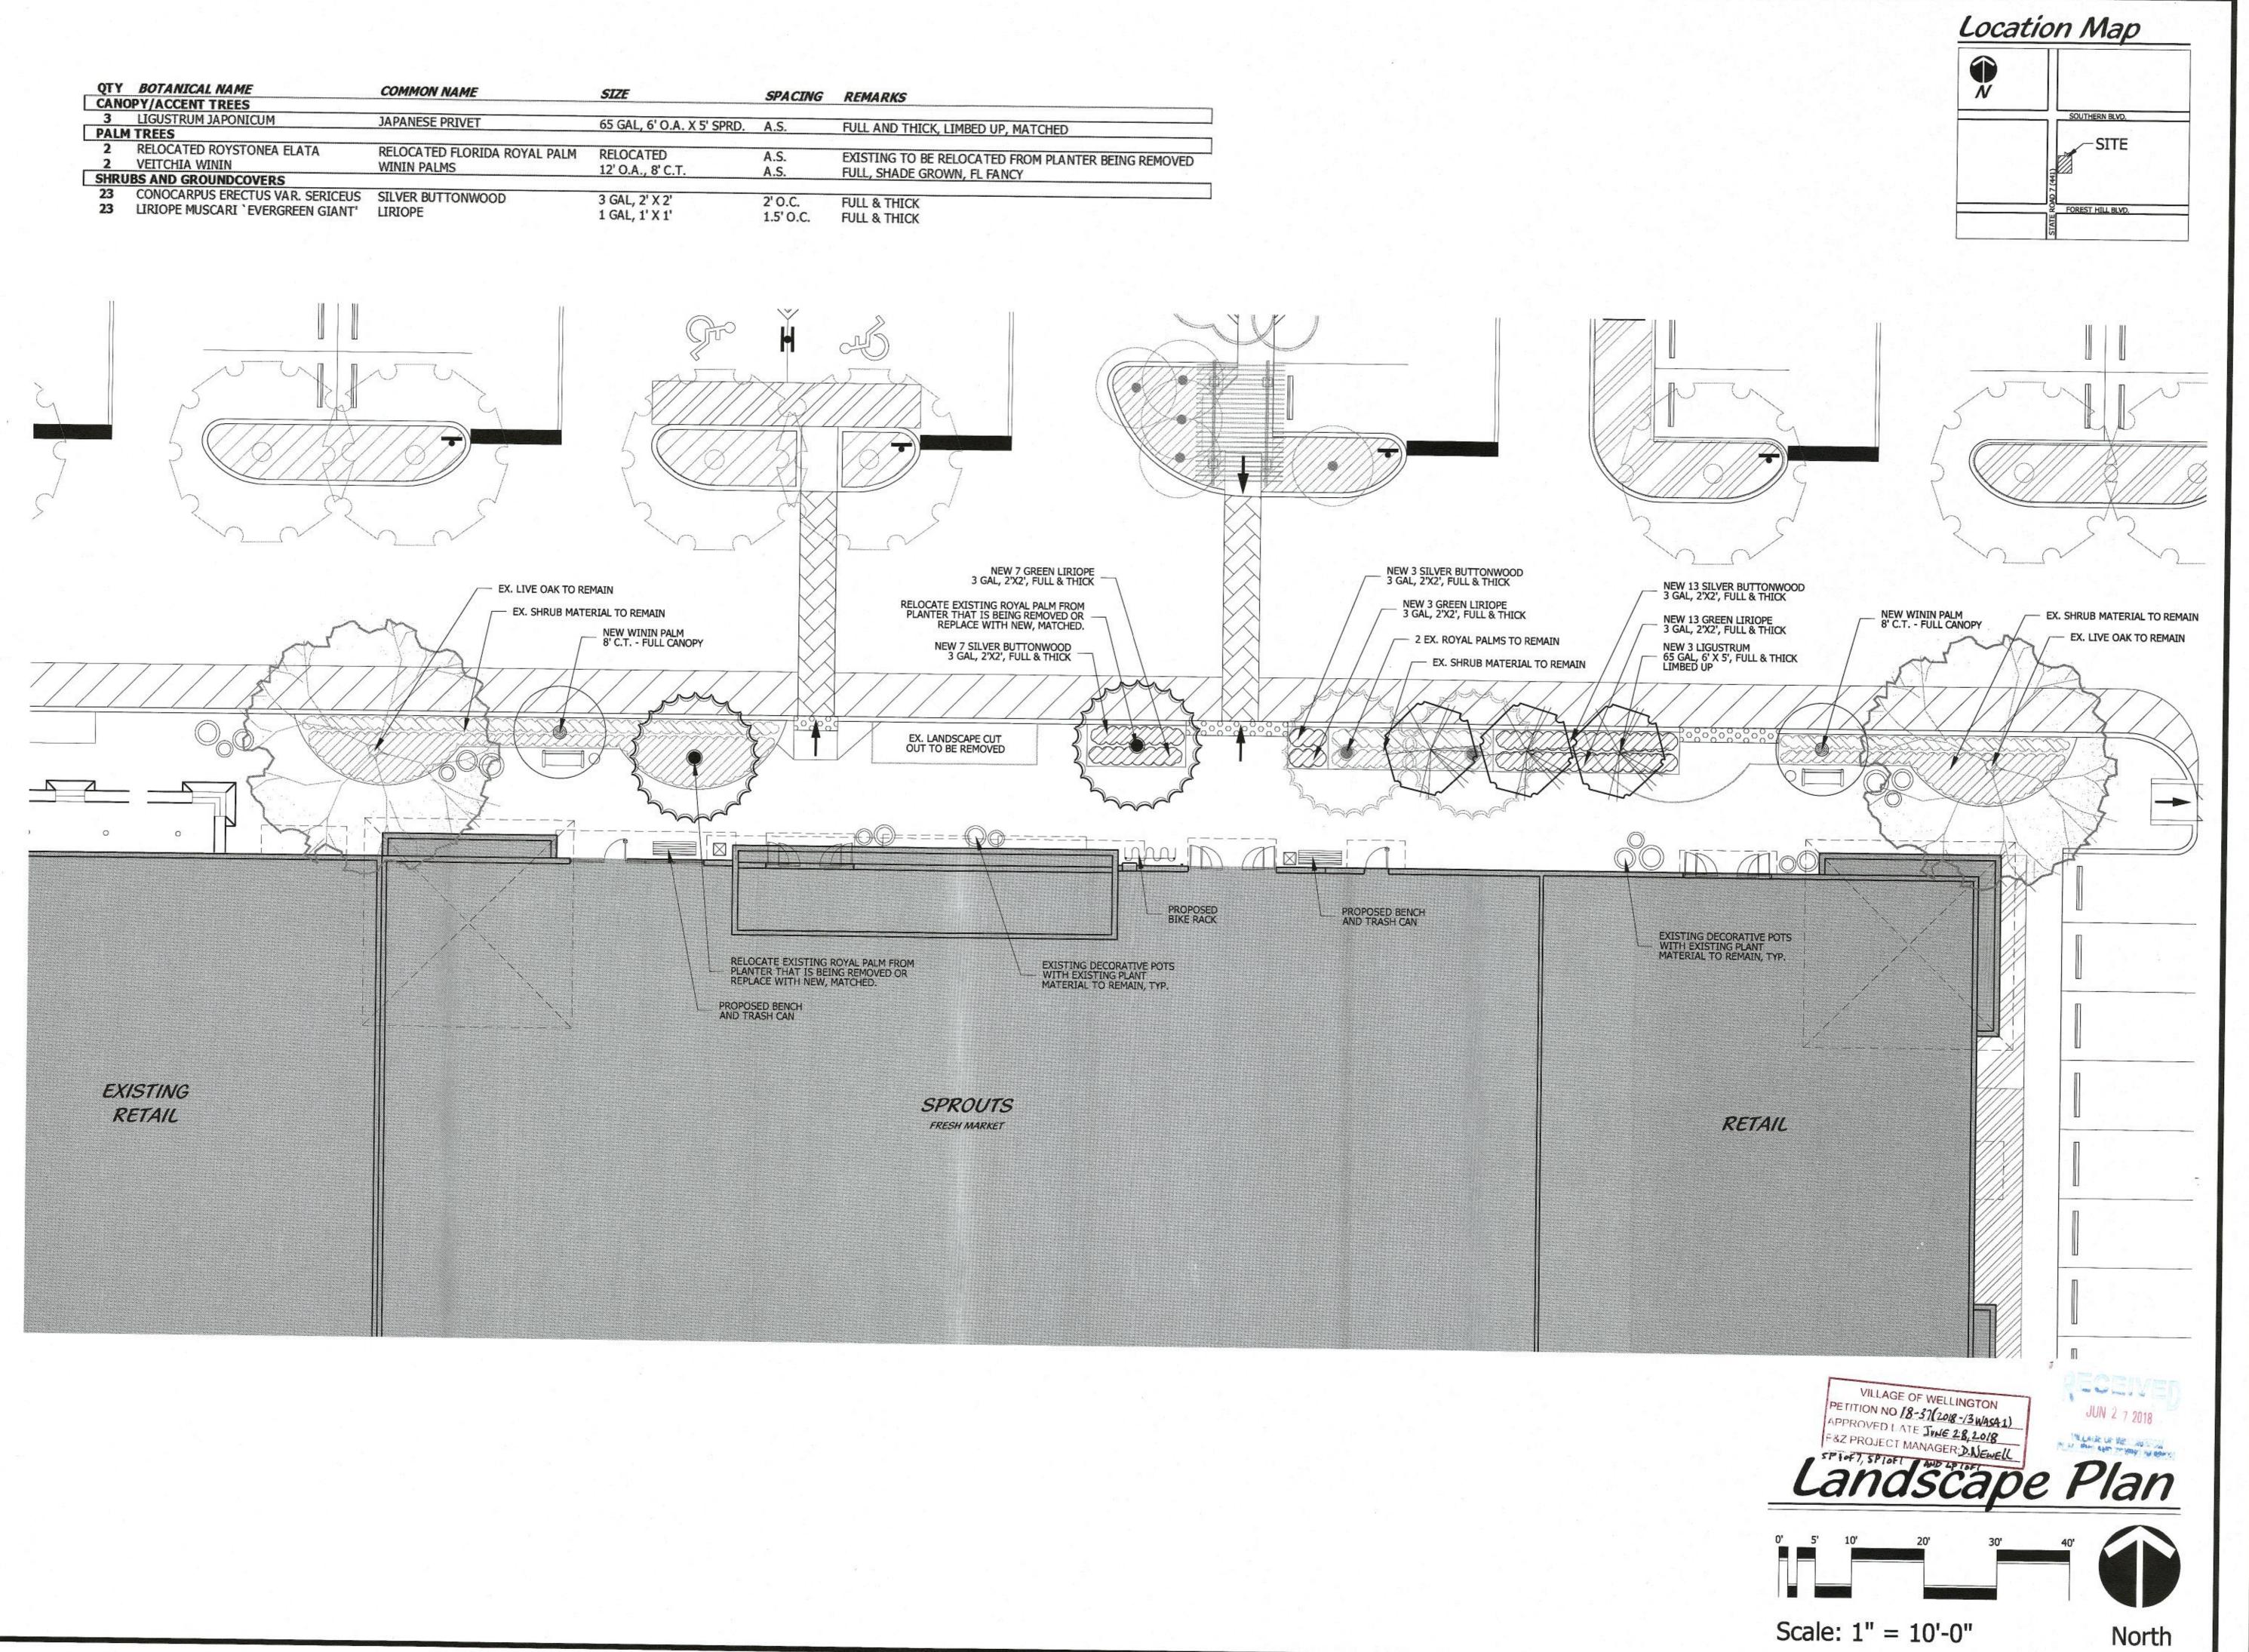1934 Commerce Lane Suite 1 Jupiter, Florida 33458 561-747-6336 Fax-747-1377


Sla Verde Commercial
Wellington Isles, u.c.

DESIGNED	DEH
DRAWN	RO
APPROVED	DEH
JOB NUMBER	04-1216.04
DATE	04-25-18
REVISIONS	06-06-18
4.5	06-21-18
	- West

June 21, 2018 3:38:34 p.m. Drawing: 04-1216 LP.DWG

SHEET 1 OF 1

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ACCESSIBILITY NOTES

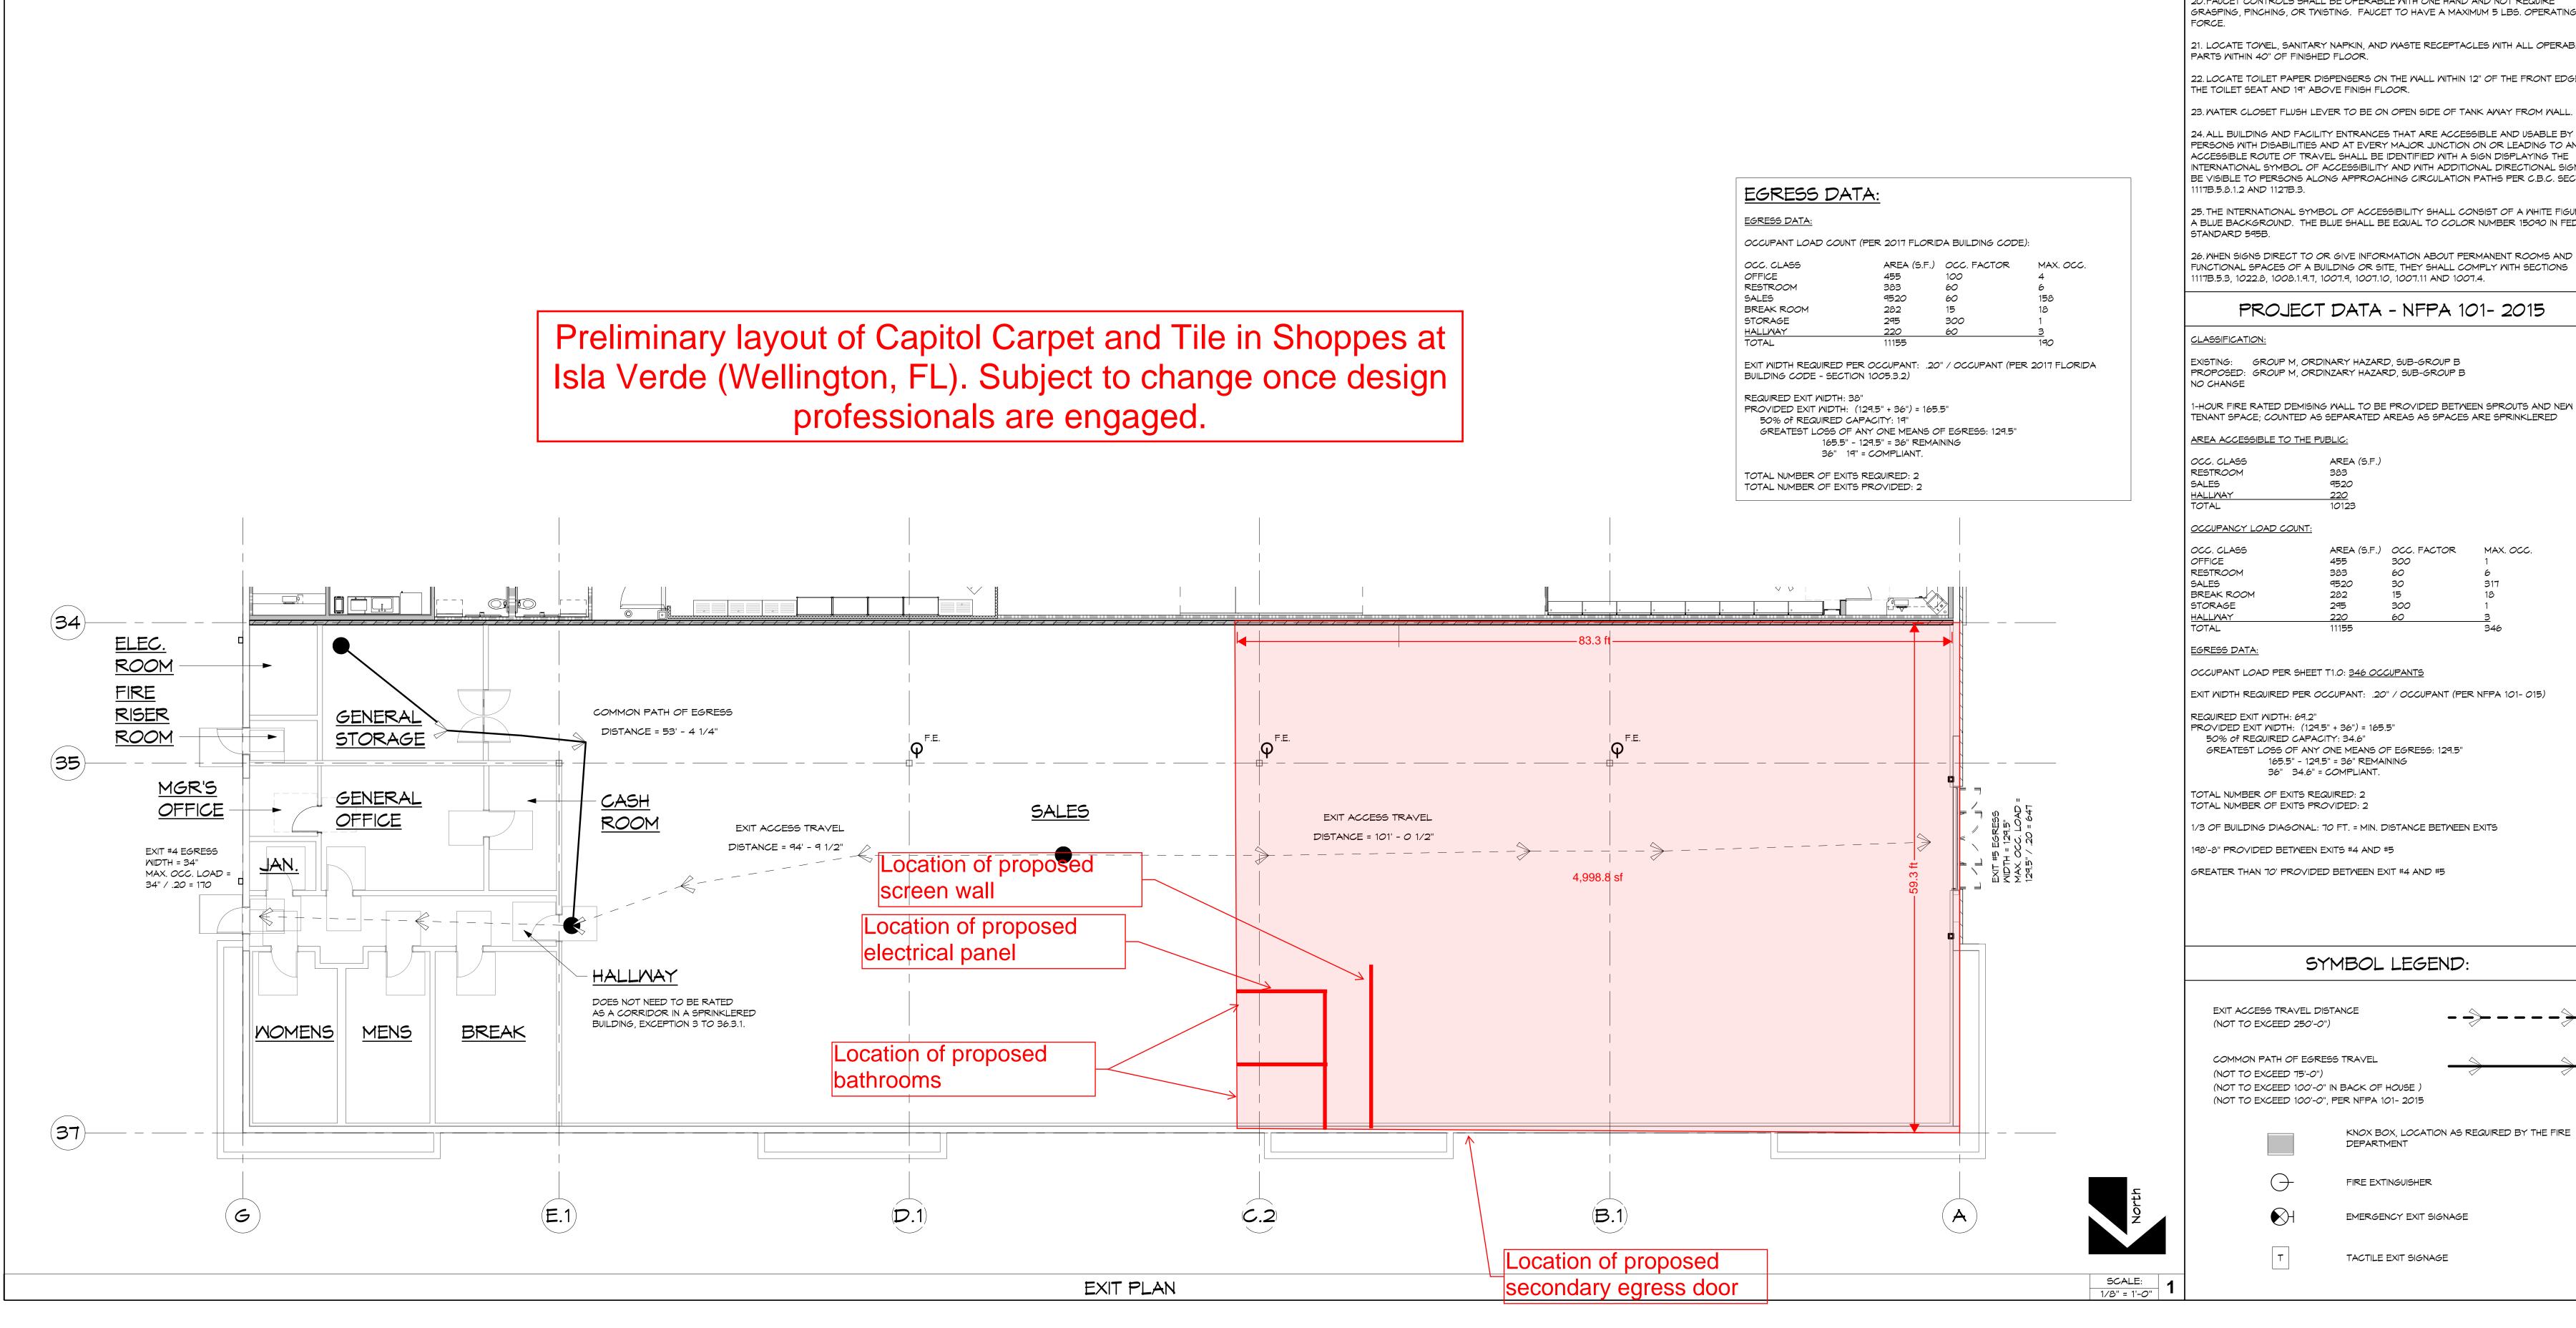DISABLED ACCESS TO THESE FACILITIES SHALL BE PROVIDED AT PRIMARY ENTRANCE.

2. THE SLOPE OF PUBLIC WALKS SHALL NOT EXCEED MAXIMUM CROSS SLOPE 2% MALKING SURFACE SLOPING GREATER THAN 2% SHALL BE SLIP RESISTANT.

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hese drawings and specifications are protection as an "architectural work"

U.S.C. As amended January 2003. The he overall form, arrangement and composition of spaces, and elements of the design. Under such protection,

specifications may result in cessation of uction, building seizure, and / or

netary liability.

3. PROVIDE A 60" X 60" MINIMUM LANDING WITH 24" OF THE LANDING BEYOND STRIKE SIDE OF DOOR WITH 44" MINIMUM WIDTH IN DIRECTION OF TRAVEL.

4. WALKS SHALL EXTEND 24" TO THE SIDE OF THE STRIKE EDGE OF A DOOR OR GATE THAT SMINGS TOMARD THE MALK.

5. RAMPS SHALL HAVE A NON-SLIP SURFACE; WITH TACTILE WARNING SURFACE. RAMPS SHALL BE 36" WIDE MINIMUM U.N.O. AND 48" WIDE WITH HANDRAILS.

6. EVERY REQUIRED EXIT DOORWAY SHALL BE SIZED FOR A DOOR NOT LESS THAN 3 FEET WIDE BY NOT LESS THAN 6'-8" HIGH CAPABLE OF OPENING 90° AND MOUNTED SO THAT THE CLEAR WIDTH OF THE EXIT WAY IS 32" MINIMUM.

7. ALUMINUM THRESHOLD TO BE A MAXIMUM 1/2" ABOVE ADJACENT FINISH FLOOR.

8. MAXIMUM EFFORT TO OPERATE DOORS SHALL NOT EXCEED 5 LBS. 9. THE BOTTOM 10" OF ALL DOORS EXCEPT AUTOMATIC AND SLIDING SHALL HAVE A SMOOTH UNINTERRUPTED SURFACE.

10. PROVIDE LEVER TYPE HARDWARE, PANIC BARS, PUSH / PULL ACTIVATING BARS, OR OTHER HARDWARE DESIGNED TO PROVIDE PASSAGE WITHOUT REQUIRING THE ABILITY TO GRASP THE OPENING HARDWARE. (30" TO 44" ABOVE FINISH FLOOR).

1. SELF CLOSING DOORS TO REMAIN OPEN FOR MINIMUM OF 10 SECONDS.

12. LOCATE WATER CLOSETS IN A 60" X 60" MINIMUM AREA, 18" FROM WALL TO CENTER LINE OF WATER CLOSET.

13. PROVIDE 48" X 48" SPACE AT PUSH SIDE OF DOOR AND 54" DEEP SPACE AT PULL SIDE OF DOOR INTO TOILET ROOM AND WATER CLOSET STALL.

14. PROVIDE 1 1/2"Ø GRAB BARS AT 33" ABOVE FINISH FLOOR AT REAR AND SIDE OF MATER CLOSET GRAB BAR AT SIDE TO BE 42" LONG AND EXTEND 35" FROM BACK WALL OF TOILET. GRAB BAR TO BE 36" LONG AT BACK WITH 1 1/2" CLEAR FROM WALL. BAR FASTENERS AND MOUNTING SUPPORTS TO WITHSTAND A MINIMUM 250 LBS. PER FOOT IN BENDING, SHEER STRESS AND SHEAR FORCE.

15. WATER CLOSETS SHALL HAVE A SEAT HEIGHT OF 17" TO 19" ABOVE FINISH FLOOR FLUSH VALVES TO HAVE A MAXIMUM 5 LBS. OPERATING FORCE.

16. URINAL TO HAVE AN ELONGATED RIM AT 17" ABOVE FINISH FLOOR MAXIMUM AND A CLEAR SPACE OF 30" x 48" IN FRONT. FLUSH VALVES TO BE MOUNTED 44" ABOVE FINISH FLOOR AND HAVE MAXIMUM 5 LBS. OPERATING FORCE.

17. PROVIDE 30" x 48" CLEAR SPACE IN FRONT OF LAVATORY AND 29" CLEAR FROM FLOOR TO BOTTOM OF APRON FOR KNEE SPACE.

18. PROVIDE A CLEARANCE 27" HIGH X 8" DEEP BEHIND FRONT OF LAVATORY AND A TOE CLEARANCE OF 9" FROM THE FLOOR AND 17" DEEP FROM THE FRONT OF THE LAVATORY.

19. INSULATE HOT WATER AND DRAIN PIPES AT SINKS. 20.FAUCET CONTROLS SHALL BE OPERABLE WITH ONE HAND AND NOT REQUIRE GRASPING, PINCHING, OR TWISTING. FAUCET TO HAVE A MAXIMUM 5 LBS. OPERATING

21. LOCATE TOWEL, SANITARY NAPKIN, AND WASTE RECEPTACLES WITH ALL OPERABLE

PARTS WITHIN 40" OF FINISHED FLOOR. 22. LOCATE TOILET PAPER DISPENSERS ON THE WALL WITHIN 12" OF THE FRONT EDGE OF

THE TOILET SEAT AND 19" ABOVE FINISH FLOOR.

24. ALL BUILDING AND FACILITY ENTRANCES THAT ARE ACCESSIBLE AND USABLE BY PERSONS WITH DISABILITIES AND AT EVERY MAJOR JUNCTION ON OR LEADING TO AN ACCESSIBLE ROUTE OF TRAVEL SHALL BE IDENTIFIED WITH A SIGN DISPLAYING THE INTERNATIONAL SYMBOL OF ACCESSIBILITY AND WITH ADDITIONAL DIRECTIONAL SIGNS TO BE VISIBLE TO PERSONS ALONG APPROACHING CIRCULATION PATHS PER C.B.C. SECTIONS 1117B.5.8.1.2 AND 1127B.3.

25. THE INTERNATIONAL SYMBOL OF ACCESSIBILITY SHALL CONSIST OF A WHITE FIGURE ON A BLUE BACKGROUND. THE BLUE SHALL BE EQUAL TO COLOR NUMBER 15090 IN FEDERAL

26. WHEN SIGNS DIRECT TO OR GIVE INFORMATION ABOUT PERMANENT ROOMS AND FUNCTIONAL SPACES OF A BUILDING OR SITE, THEY SHALL COMPLY WITH SECTIONS 1117B.5.3, 1022.8, 1008.1.9.7, 1007.9, 1007.10, 1007.11 AND 1007.4.

## PROJECT DATA - NFPA 101- 2015

EXISTING: GROUP M, ORDINARY HAZARD, SUB-GROUP B PROPOSED: GROUP M. ORDINZARY HAZARD, SUB-GROUP B

TENANT SPACE; COUNTED AS SEPARATED AREAS AS SPACES ARE SPRINKLERED

AREA ACCESSIBLE TO THE PUBLIC:

OCC. CLASS RESTROOM

OCCUPANCY LOAD COUNT:

OCC. CLASS 455 RESTROOM 9520 BREAK ROOM 282 295

EGRESS DATA:

OCCUPANT LOAD PER SHEET T1.0: 346 OCCUPANTS

EXIT WIDTH REQUIRED PER OCCUPANT: .20" / OCCUPANT (PER NFPA 101- 015)

PROVIDED EXIT MIDTH: (129.5" + 36") = 165.5" 50% of REQUIRED CAPACITY: 34.6" GREATEST LOSS OF ANY ONE MEANS OF EGRESS: 129.5" 165.5" - 129.5" = 36" REMAINING

TOTAL NUMBER OF EXITS REQUIRED: 2

TOTAL NUMBER OF EXITS PROVIDED: 2 1/3 OF BUILDING DIAGONAL: 70 FT. = MIN. DISTANCE BETWEEN EXITS

36" 34.6" = COMPLIANT.

198'-8" PROVIDED BETWEEN EXITS #4 AND #5

GREATER THAN 70' PROVIDED BETWEEN EXIT #4 AND #5

## SYMBOL LEGEND:

EXIT ACCESS TRAVEL DISTANCE (NOT TO EXCEED 250'-0")

COMMON PATH OF EGRESS TRAVEL (NOT TO EXCEED 75'-0") (NOT TO EXCEED 100'-0" IN BACK OF HOUSE ) (NOT TO EXCEED 100'-0", PER NFPA 101- 2015



FIRE EXTINGUISHER

EMERGENCY EXIT SIGNAGE



TACTILE EXIT SIGNAGE

DRAWN BY: AAD: FITCH 320108628

NUMBER:

30°, 7/25/18

lorida License No. AR95882

05-25-18 **AS NOTED**