
C-2 CANAL PROJECT

FORCEMAIN REPLACEMENT PROJECT FOREST HILL BOULEVARD CROSSING AND C-2 CANAL CROSSING

PREPARED FOR





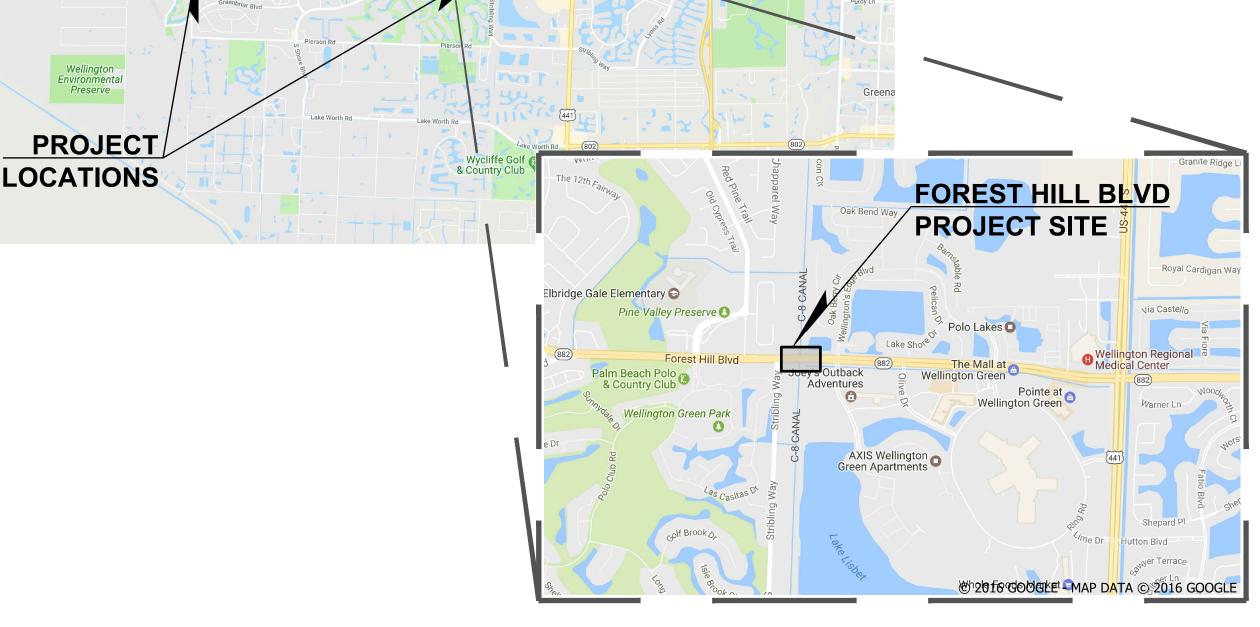

VILLAGE COUNCIL

ANNE GERWIG, MAYOR MICHAEL DRAHOS, VICE MAYOR JOHN T. MCGOVERN, COUNCILMAN MICHAEL J. NAPOLEONE, COUNCILMAN TANYA SISKIND, COUNCILWOMAN

VILLAGE MANAGER

PAUL SCHOFIELD

UTILITIES DIRECTOR SHANNON LAROCQUE, PE

INDEX OF SHEETS

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C-2 CANAL SITE STORMWATER POLLUTION PREVENTION PLAN

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EXISTING C-2 CANAL SITE - PLAN VIEW

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VILLAGE OF WELLINGTON STANDARD DETAILS

VILLAGE OF WELLINGTON STANDARD DETAILS

VILLAGE OF WELLINGTON STANDARD DETAILS

VILLAGE OF WELLINGTON STANDARD DETAILS

VILLAGE OF WELLINGTON STANDARD DETAILS

DETAILS

TOTAL NUMBER OF SHEETS: 15

VICINITY MAP

SECTION 7, TOWNSHIP 44 SOUTH, RANGE 41 EAST SECTION 11, TOWNSHIP 44 SOUTH, RANGE 41 EAST



BAR IS EQUAL TO ONE INCH ON ORIGINAL DRAWING ADJUST ALL SCALED

1/ 3/12/2019 | TET | REVISIONS PER VOW CADD FILE: NO. DATE BY REVISION

SEAL SPENCER M. SCHROEDER FLORIDA P.E. NO. 65693 DATE

MOCK•ROOS CONSULTING ENGINEERS


FIELD: --DRAWN: TET DESIGN: SMS/TET APPR: GGG 5720 Corporate Way, West Palm Beach, Florida 33407 (561) 683-3113, www.MockRoos.com SCALE: AS SHOWN

FORCEMAIN REPLACEMENT PROJECT FOREST HILL BOULEVARD CROSSING AND C-2 CANAL CROSSING THE VILLAGE OF WELLINGTON

PALM BEACH COUNTY, FLORIDA

DATE: JANUARY 2019 B8705.00 P.A. NO. DWG. NO. 44-41-11-16 SHEET: C0-1



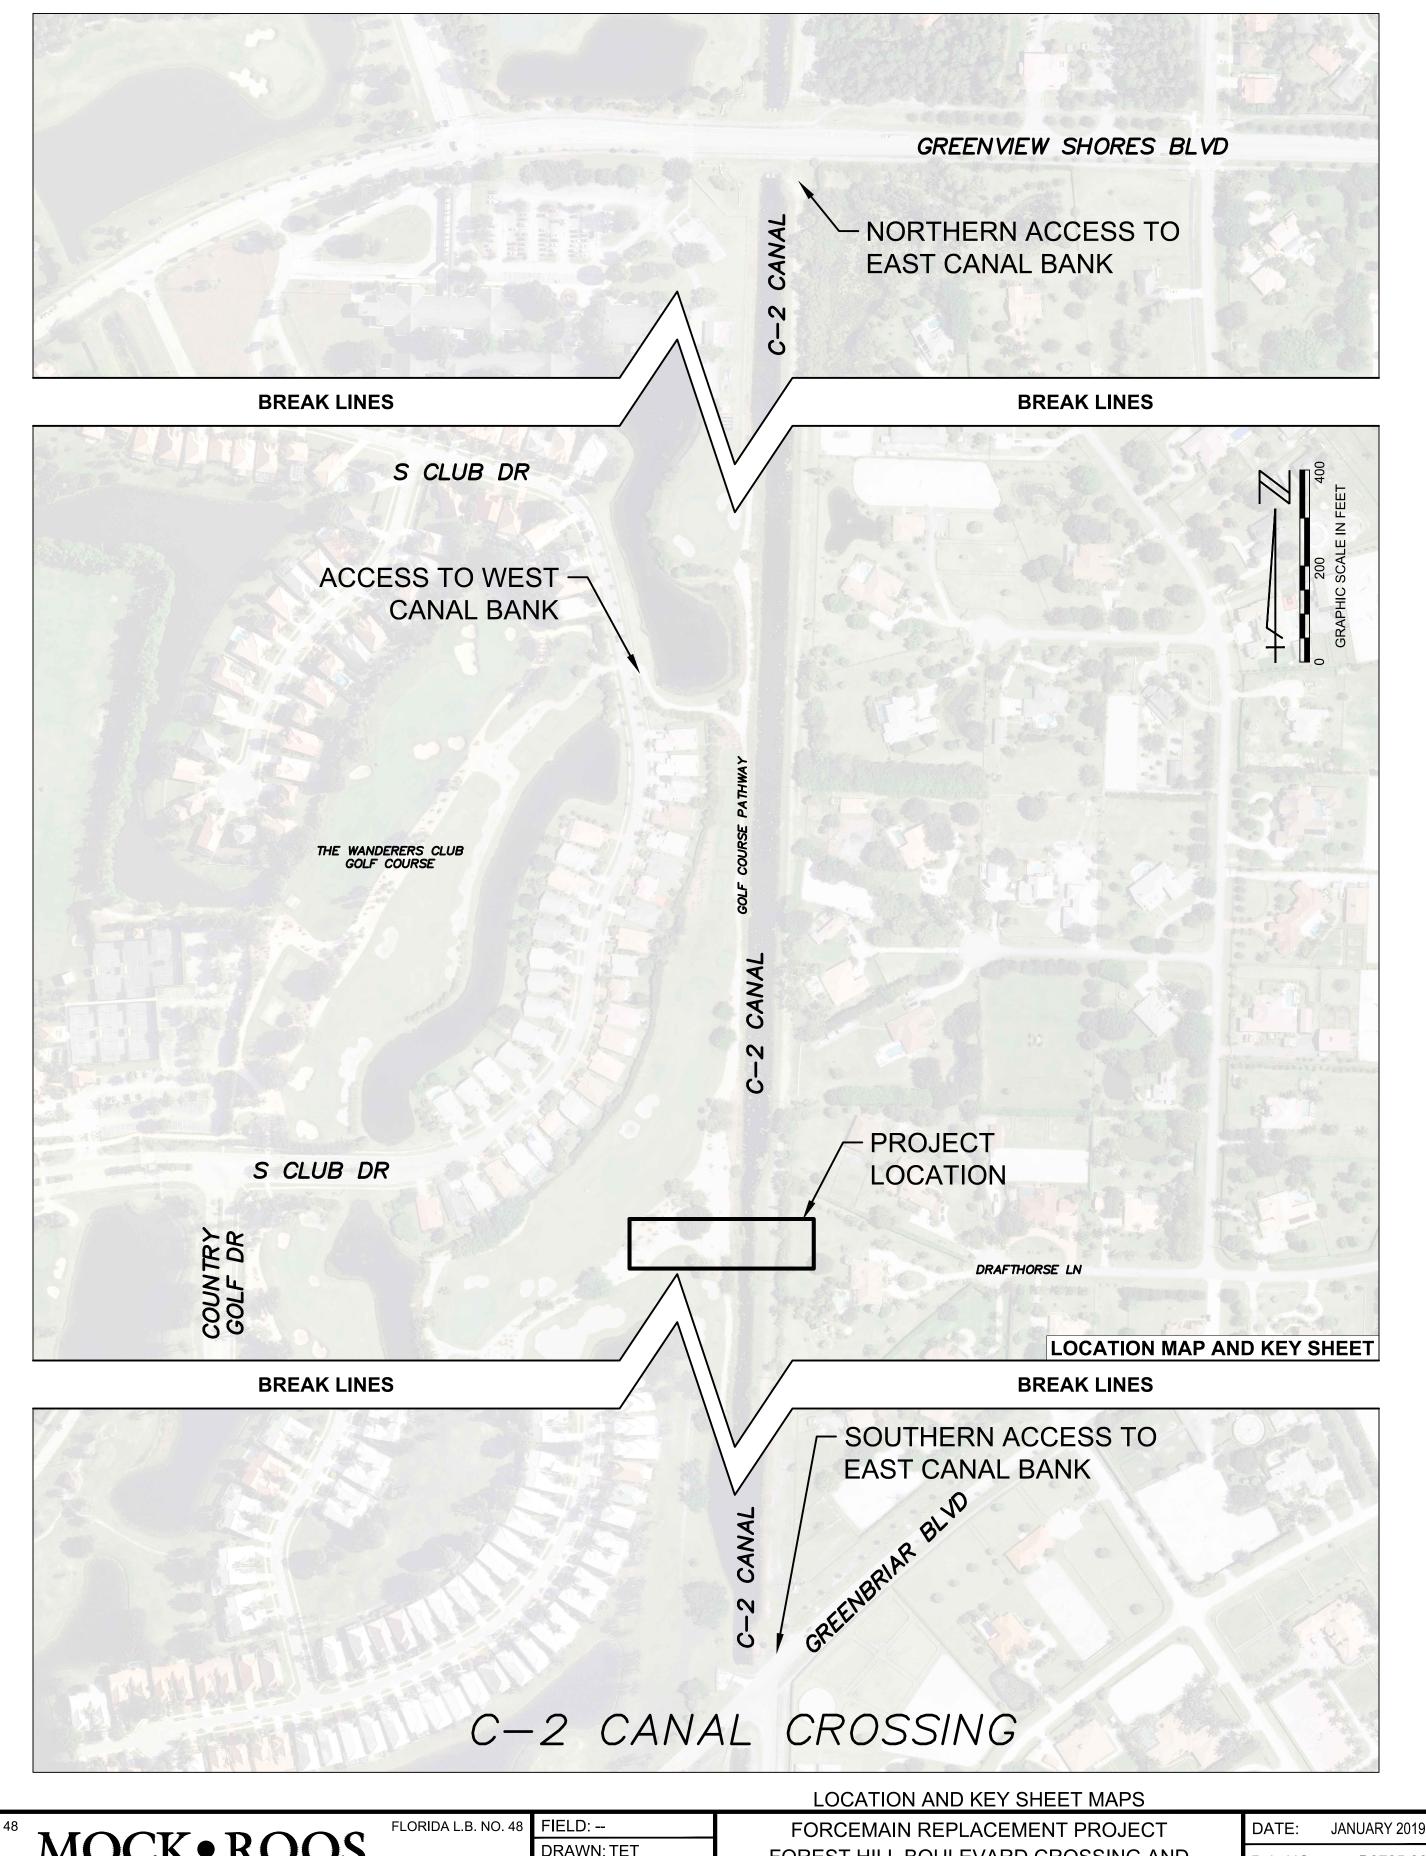

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DIMENSIONS ACCORDINGLY

CADD FILE: F:\well\wellfmdd\CAD\DWG\ NO. DATE BY REVISION

SEAL SPENCER M. SCHROEDER FLORIDA P.E. NO. 65693 DATE

MOCK•ROOS CONSULTING ENGINEERS

DRAWN: TET DESIGN: SMS/TET APPR: GGG 5720 Corporate Way, West Palm Beach, Florida 33407 (561) 683-3113, www.MockRoos.com SCALE: AS SHOWN FOREST HILL BOULEVARD CROSSING AND C-2 CANAL CROSSING THE VILLAGE OF WELLINGTON PALM BEACH COUNTY, FLORIDA

P.A. NO. B8705.00 DWG. NO. 44-41-11-16 C0-2 SHEET:

GENERAL NOTES:

- 1. ALL ELEVATIONS ARE REFERENCED TO THE NORTH AMERICAN VERTICAL DATUM OF 1988 (NAVD88).
- ALL WORK SHALL BE PERFORMED IN ACCORDANCE WITH FDOT SPECIFICATIONS, LATEST ADDITION AND THE VILLAGE OF WELLINGTON STANDARD SPECIFICATIONS. ALL MATERIALS SHALL CONFORM TO THE CURRENT APPROVED PRODUCTS LIST FOR THE VILLAGE OF WELLINGTON.
- ALL PROPOSED GRADES SHOWN ARE FINISHED GRADES, UNLESS OTHERWISE NOTED. THE CONTRACTOR SHALL SLOPE FINISHED GRADES UNIFORMLY BETWEEN OTHER FINISHED AND EXISTING $\sqrt{1/30}$. GRADES AND IN SUCH A MANNER TO PREVENT STORMWATER PONDING.
- CONTRACTOR SHALL BE RESPONSIBLE FOR ALL REMOVAL, DISPOSAL, ABANDONMENT, AND RELOCATIONS NECESSARY TO COMPLETE THE WORK WHETHER SHOWN ON THE DRAWINGS OR NOT. CONTRACTOR SHALL COORDINATE RELOCATIONS WITH THE NECESSARY UTILITY COMPANIES.
- CONTRACTOR SHALL RESTORE ALL AREAS DISTURBED BY THE CONTRACTOR'S ACTIVITIES INVOLVING CONSTRUCTION, STAGING AREAS, AND ACCESS ROADS IN KIND. ALL DISTURBED NON-PAVED AREAS SHALL BE PLANTED WITH "IN-KIND" VEGETATION.
- CONTRACTOR SHALL SUBMIT AN M.O.T. PLAN CONFORMING TO FDOT INDEX NO. 102-600 AND AS REQUIRED IN THE PROJECT SPECIFICATIONS. THE PLAN SHALL PROVIDE FOR TWO-WAY TRAFFIC FLOW AT ALL TIMES. CONTRACTOR SHALL FOLLOW THE APPROVED PLAN THROUGHOUT PROJECT DURATION. ACCESS TO PRIVATE PROPERTIES AND PUBLIC SIDE STREETS SHALL BE PROVIDED AT ALL TIMES.
- CONTRACTOR SHALL SUBMIT A PROPOSED PHASING PLAN SHOWING BOTH CONSTRUCTION AND MAINTENANCE OF TRAFFIC PHASING.
- CONTRACTOR SHALL COORDINATE WITH THE NECESSARY UTILITY COMPANIES AND SUNSHINE 811 (811 OR 1-800-432-4770) FOR ALL UTILITY LOCATES 48 HOURS PRIOR TO COMMENCEMENT OF CONSTRUCTION.
- PRIOR TO COMMENCEMENT OF ANY EXCAVATION, THE CONTRACTOR SHALL COMPLY WITH CHAPTER 556 OF THE FLORIDA STATUTES: THE UNDERGROUND FACILITY DAMAGE PREVENTION AND SAFETY
- 10. CONTRACTOR SHALL MAINTAIN A NEAT, ORDERLY, AND SAFE SITE AT ALL TIMES.
- 11. ALL SURVEY MONUMENTS WITHIN LIMITS OF CONSTRUCTION ARE TO BE PROTECTED. IF IN DANGER OF DAMAGE THE CONTRACTOR SHALL NOTIFY: NATIONAL GEODETIC INFORMATION SERVICES CENTER NOAA NATIONAL GEODETIC SURVEY, N/CG 17 SSMC 3, STATION 09202 SILVER SPRING, MARYLAND 20910 TELEPHONE NO. (301) 713-3242.
- 12. CONTRACTOR SHALL APPLY FOR AND COMPLY WITH THE REQUIREMENTS OF THE FDEP GENERIC PERMIT FOR STORMWATER DISCHARGE FROM LARGE AND SMALL CONSTRUCTION SITES.
- 13. CONTRACTOR SHALL UTILIZE CONSTRUCTION METHODS AND DEVICES SUCH AS SILT FENCES AND INLET PROTECTION WHERE NECESSARY IN ORDER TO COMPLY WITH THE STATE AND LOCAL WATER QUALITY STANDARDS AND NATIONAL POLLUTION DISCHARGE ELIMINATION SYSTEM (N.P.D.E.S.) REQUIREMENTS. CONTRACTOR SHALL PREPARE AND SUBMIT TO THE ENGINEER FOR REVIEW A STORMWATER POLLUTION PREVENTION PLAN (SWPPP).
- 14. ALL WORK SHALL BE OPEN AND SUBJECT TO INSPECTION BY AUTHORIZED PERSONNEL OF THE VILLAGE OF WELLINGTON, ALL INVOLVED UTILITY COMPANIES, THE PROJECT ENGINEER AND ALL REGULATORY AGENCIES.
- 15. WHERE EXCAVATIONS TO A DEPTH IN EXCESS OF FIVE FEET (5') ARE REQUIRED, THE CONTRACTOR
- SHALL INCLUDE THE FOLLOWING INFORMATION IN THE BID: A. REFERENCE TO THE TRENCH SAFETY STANDARDS THAT WILL BE IN EFFECT DURING THE PERIOD OF CONSTRUCTION OF THE PROJECT.
- WRITTEN ASSURANCES BY THE CONTRACTOR PERFORMING THE TRENCH EXCAVATION THAT SUCH CONTRACTOR WILL COMPLY WITH THE FLORIDA TRENCH SAFETY ACT.
- 16. ALL OPEN TRENCHES AND HOLES ADJACENT TO ROADWAYS OR WALKWAYS SHALL BE PROPERLY MARKED AND BARRICADED TO ASSURE THE SAFETY OF BOTH VEHICULAR AND PEDESTRIAN TRAFFIC. NO TRENCHES OR HOLES NEAR WALKWAYS OR IN ROADWAYS OR SHOULDERS ARE TO BE LEFT OPEN DURING NIGHTTIME HOURS.
- PRIOR TO CONSTRUCTION, THE CONTRACTOR SHALL BE REQUIRED TO SUBMIT A CONSTRUCTION SCHEDULE DEPICTING EACH PHASE OF THE WORK. THE SCHEDULE SHALL BE SUBJECT TO REVIEW AND APPROVAL BY THE OWNER AND ENGINEER PRIOR TO COMMENCEMENT OF ANY WORK.
- 18. CONTRACTOR SHALL PROMPTLY REMOVE ALL MUD, DIRT OR OTHER MATERIALS TRACKED OR SPILLED ONTO EXISTING PUBLIC ROADS AND FACILITIES DUE TO CONSTRUCTION.
- 19. ALL EXCESS FILL AND DEBRIS FROM THE SITE SHALL BE LEGALLY DISPOSED OF OFF-SITE BY THE CONTRACTOR.
- 20. ALL UTILITIES (MANHOLE, VALVE, ELECTRIC RINGS AND TOPS) SHALL BE ADJUSTED TO NEW FINISH GRADES AND PROPERLY SET TO PAVEMENT CROSS SLOPE AS REQUIRED.
- 21. CONTRACTOR SHALL COORDINATE WITH THE VILLAGE OF WELLINGTON FOR THE SELECTION OF
- PROPOSED CONSTRUCTION STAGING AREAS AND/OR STOCKPILING OF MATERIALS. 22. CONTRACTOR SHALL COORDINATE ALL SITE WORK FOR PEDESTRIAN AND TRAFFIC CONTROL WITH THE VILLAGE OF WELLINGTON ENGINEERING DEPARTMENT: JONATHAN REINSVOLD, P.E. OFFICE:
- 561-791-4052. 23. CONTRACTOR SHALL LIMIT ACCESS AND CONSTRUCTION OPERATIONS TO WITHIN LIMITS OF THE
- PUBLIC ROAD AND CANAL RIGHTS-OF-WAY. THE CONTRACTOR SHALL BE SOLELY RESPONSIBLE FOR ANY DAMAGES OUTSIDE THE LIMITS OF THE ROAD AND CANAL RIGHTS-OF-WAY.
- 24. AREAS FOR THE STORAGE OF EXCAVATED MATERIAL ARE LIMITED. SUCH MATERIAL MAY BE REMOVED AND STORED OFFSITE AND RETURNED FOR BACKFILLING.
- 25. CONTRACTOR SHALL HAVE NO TRENCHES OPEN AT THE END OF EACH WORK DAY. IF NECESSARY, TRENCHES SHALL BE TEMPORARILY BACKFILLED AND BARRICADED.
- 26. THE AERIAL PHOTOGRAPH USED FOR THIS PROJECT WAS PREPARED FROM THE PALM BEACH COUNTY DATA BASE AND AS SUCH SHOULD BE USED ONLY AS SCHEMATICS.
- 27. SOURCE AND DATE OF AERIAL PHOTOGRAPHY: PBC GIS DATED 2017.

- 28. CONTRACTOR SHALL USE CAUTION AND TAKE THE NECESSARY SAFETY PRECAUTIONS WHILE WORKING ADJACENT TO OVERHEAD AND UNDERGROUND ELECTRIC.
- 29. PRIOR TO CONSTRUCTION, THE CONTRACTOR SHALL LOCATE AND DOCUMENT THE LOCATIONS OF THE EXISTING IRRIGATION SYSTEM WITHIN THE PROJECT BOUNDARIES. THE CONTRACTOR WILL BE RESPONSIBLE AS PART OF THIS CONTRACT TO RESTORE THE EXISTING IRRIGATION SYSTEM TO ORIGINAL OR BETTER CONDITIONS. PLEASE COORDINATE YOUR EFFORTS WITH CHRIS CUMSTON @ 561-791-4117 OR BRIAN HOPPER @ 561-791-4126.
- CONTRACTOR MUST PREPARE AND SUBMIT A FRAC-OUT CONTINGENCY AND RESPONSE PLAN FOR THE HORIZONTAL DIRECTIONAL DRILL UNDERNEATH THE C-2 CANAL. THE PLAN SHALL BE PREPARED BY A QUALIFIED INDIVIDUAL AND IS SUBJECT TO REVIEW AND APPROVAL BY THE OWNER AND ENGINEER PRIOR TO COMMENCEMENT OF ANY HORIZONTAL DIRECTIONAL DRILLING ACTIVITIES.
- 31. CONTRACTOR SHALL COORDINATE ALL RESTORATION REQUIREMENTS FOR THE WASTE BUNKER AND ANY OTHER DISTURBED AREAS ON THE WEST SIDE OF THE C-2 CANAL WITH GOLF COURSE REPRESENTATIVES. CONTRACTOR SHALL MAKE EVERY EFFORT TO CONTAIN CONSTRUCTION ACTIVITIES WITHIN THE EXISTING EASEMENT.
- 32. VEGETATION WITHIN THE RIGHT-OF-WAY ON THE EAST SIDE OF THE C-2 CANAL SHALL BE REMOVED AS NECESSARY FOR CONSTRUCTION. THE CONTRACTOR SHALL PROTECT AND PRESERVE ANY SPECIMEN PALMS IN THE AREA IF POSSIBLE.
- 33. ACCESS TO THE EAST SIDE OF THE C-2 CANAL SHALL BE THROUGH THE VEHICLE GATE AT THE C-2 CANAL AND GREENBRIAR BLVD. ACCESS TO THE WEST SIDE OF THE C-2 CANAL SHALL BE FROM THE CART PATH CROSSING ON S. CLUB DR. CONTRACTOR SHALL KEEP VEHICLE AND CONSTRUCTION TRAFFIC LIMITED TO CART PATH AREA. CONTRACTOR IS SOLELY RESPONSIBLE FOR RESTORATION OF ALL AREAS DISTURBED DURING CONSTRUCTION.

SURVEY NOTES - FOREST HILL BLVD CROSSING (PREPARED BY DENNIS J. LEARY & ASSOCIATIONS):

- 1. The survey depicted hereon has been classified as a Topographic Survey, as defined in Rule 5J-17.050 (10)(K) of the Florida Administrative Code, pursuant to Chapter 472,027, Florida Statutes as amended.
- 2. This survey has been prepared in the office of Dennis J. Leavy & Associates, Inc. located at: 460 Business Park Way, Suite B, Royal Palm Beach, Florida, whose certificate of authorization number is LB6599, and the certifying surveyor's (David A. Bower) license number is LS5888.
- 3. This survey does not address environmental matters, jurisdictional boundaries or hazardous waste concerns should any of the foregoing exist.
- 4. THIS IS NOT A BOUNDARY SURVEY
- 5. The elevations shown hereon are for the purpose of indicating the ground elevation only at the position shown and in no way indicate elevations at any other point than shown hereon and do not determine sub surface conditions.
- 6. Coordinates shown hereon are based on the North American Datum of 1983, on the 1990 adjustment for the Florida Transverse Mercator Projection-East Zone.
- 7. Date of field survey: December 27th, 2016, as recorded in Field Book 440, Pages 07-09, 11, 13-17.
- 8. This survey lies within Section 11, 12, 13 & 14, Township 44 South, Range 41 East, Palm Beach County, Florida.
- 9. Measurements shown hereon are expressed in feet and decimal parts thereof unless otherwise noted.
- 10. Benchmark of Origin: Palm Beach County Benchmark "CHALLAH" and "BRIOCHE" whose published elevations are 16.816' and 16.835' respectively, based on the North American Vertical Datum of 1988. Elevations referenced hereon are based on the North American Vertical Datum of 1988 (NAVD 88).
- 11. The elevations referred to on the Flood insurance Rate Map reference the National Geodetic Vertical Datum of 1929 (NGVD 29), this survey has been prepared with reference to the North American Vertical datum of 1988 (NAVD 88), see below for conversion factor at this site.


SURVEY NOTES - C-2 CANAL CROSSING (PREPARED BY DENNIS J. LEARY & ASSOCIATIONS):

- 1. The survey depicted hereon has been classified as a Topographic Survey, as defined in Rule 5J-17.050 (12) of the Florida Administrative Code, pursuant to Chapter 472.027, Florida Statutes as amended.
- 2. This survey has been prepared in the office of Dennis J. Leavy & Associates, Inc. located at: 460 Business Park Way, Suite B. Royal Palm Beach. Florida, whose certificate of authorization number is LB6599, and the certifying surveyor's (David A. Bower) license number is LS5888.
- 3. This survey does not address environmental matters, jurisdictional boundaries or hazardous waste concerns should any of the foregoing exist.
- 4. THIS IS NOT A BOUNDARY SURVEY
- 5. The elevations shown hereon are for the purpose of indicating the ground elevation only at the position shown and in no way indicate elevations at any other point than shown hereon and do not determine sub surface conditions.
- 6. Coordinates shown hereon are based on the North American Datum of 1983, on the 1990 adjustment for the Florida Transverse Mercator Projection-East Zone.
- 7. Date of field survey: October 31st, 2018, as recorded in Field Book 471, pages 45 through 47.
- 8. This survey lies within Section 7 & 8, Township 44 South, Range 41 East, Palm Beach County, Florida.
- 9. Measurements shown hereon are expressed in feet and decimal parts thereof unless otherwise noted.
- 10. Benchmark of Origin: Palm Beach County Benchmark "KELLER" and "MARLIN" whose published elevations are 16.012' and 12.574' respectively, based on the North American Vertical Datum of 1988.
- 11. Elevations referenced hereon are based on the North American Vertical Datum of 1988 (NAVD 88).

ENGINEERING LEGEND:

ASSOCIATION OF AMERICAN STATE HIGHWAY TRANSPORTATION OFFICIALS BASELINE BTM BOTTOM BURIED ELECTRIC (EXISTING UTILITY LOCATION) BURIED FIBER OPTIC CABLE (EXISTING UTILITY LOCATION) CENTERLINE CIP CAST IRON PIPE CONC CONCRETE CONST. CONSTRUCTION STA:59+75.16 -OFF:28.50'R CONTROL POINT EL: 16.46 CORRUGATED METAL PIPE DIRECT BURIED CABLE DIA. DIAMETER **DUCTILE IRON PIPE** EAST **EASTING ELEVATION EXIST EXISTING** FLG FLANGE FΜ **FORCEMAIN** INV INVERT L.F. LINEAR FEET MH MANHOLE **NGVD** NATIONAL GEODETIC VERTICAL DATUM **NORTH** NORTHING NO. NUMBER POLYVINYL CHLORIDE PIPE POINT OF INTERSECTION POINT OF CURVATURE POINT OF TANGENCY RADIUS **RCP** REINFORCED CONCRETE PIPE **RESTRAIN JOINT** SANITARY SEWER SIGN STATION STORM DRAIN (EXISTING UTILITY LOCATION) STORM SEWER STRUCTURE SOUTH TEST HOLE T.O.P. TOP OF PIPE **TYPICAL** TYP VCP VITRIFIED CLAY PIPE WM WATERMAIN WATERMAIN (EXISTING UTILITY LOCATION) WIDTH: WEST

CIVIL DETAIL, CALL OUT SYMBOLS

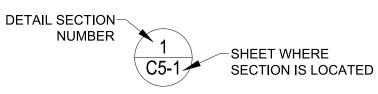

SUBSURFACE UTILITY EXPLORATION

VERIFIED VERTICAL AND HORIZONTAL LOCATIONS (Vvh) ARE PROVIDED FOR INFORMATIONAL PURPOSES ONLY AND IS BASED ON TEST HOLE REPORT DATED JUNE 2017 PROVIDED BY INFRAMAP CORP.

FOREST HILL BLVD CROSSING

NOTE: TO CONVERT FROM NAVD 88 TO NGVD 29 DATUM ADD 1.41 FEET TO THE NAVD 88 ELEVATION. EXAMPLE: EL.= 10.00' (NAVD 88) EL.= 11.41' (NGVD 29)

GENERAL NOTES, SURVEY NOTES, AND LEGEND

FORCEMAIN REPLACEMENT PROJECT FOREST HILL BOULEVARD CROSSING AND C-2 CANAL CROSSING

B8705.00 P.A. NO. DWG. NO. 44-41-11-16 SHEET: C0-3

DATE: JANUARY 2019

BAR IS EQUAL TO ONE INCH ON ORIGINAL DRAWING

ADJUST ALL SCALED

CADD FILE: :\well\wellfmdd\CAD\DWG\ NO. DATE BY REVISION FMDDCS01 C0-2.dwg

SEAL SPENCER M. SCHROEDER FLORIDA P.E. NO. 65693 DATE

FLORIDA E.B. NO. 48 MOCK•ROOS

CONSULTING ENGINEERS

5720 Corporate Way, West Palm Beach, Florida 33407 (561) 683-3113, www.MockRoos.com

FLORIDA L.B. NO. 48

APPR: GGG SCALE: AS SHOWN

DRAWN: TET

DESIGN: SMS/TET

FIELD: --

C-2 CANAL CROSSING


NOTE: TO CONVERT FROM NAVD 88 TO NGVD 29 DATUM


ADD 1.42 FEET TO THE NAVD 88 ELEVATION.


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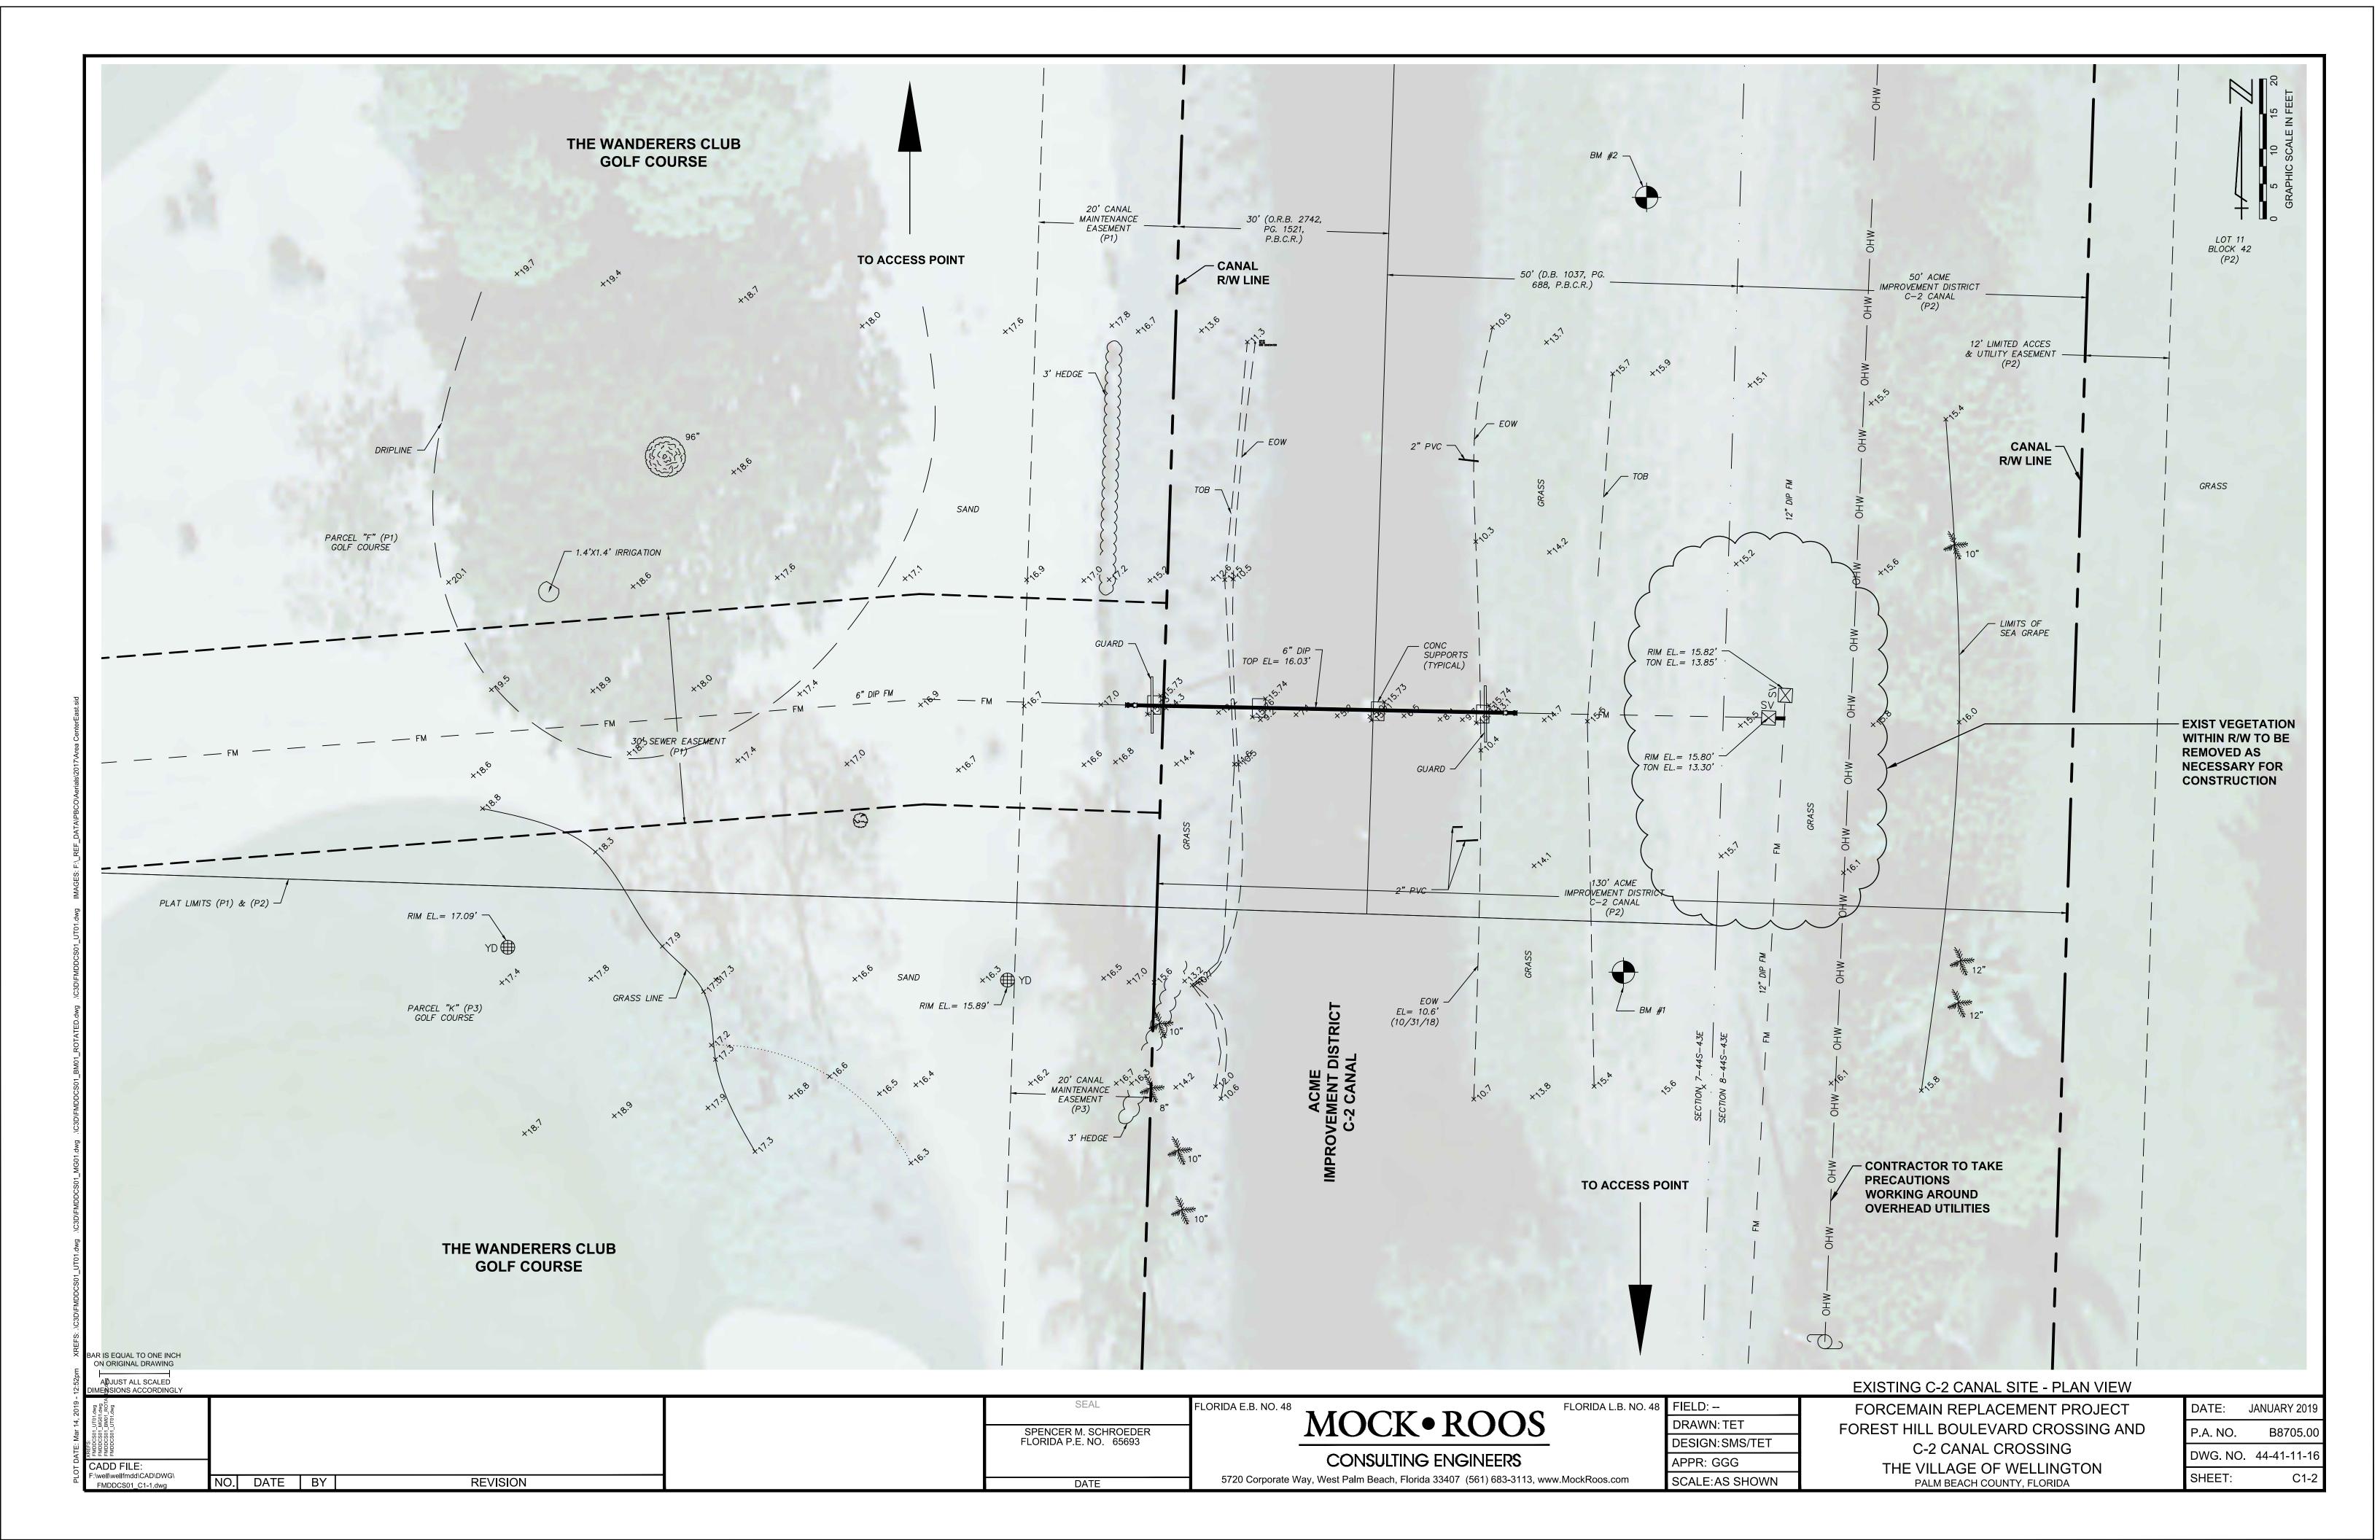
EL.= 11.42' (NGVD 29)


THE VILLAGE OF WELLINGTON PALM BEACH COUNTY, FLORIDA




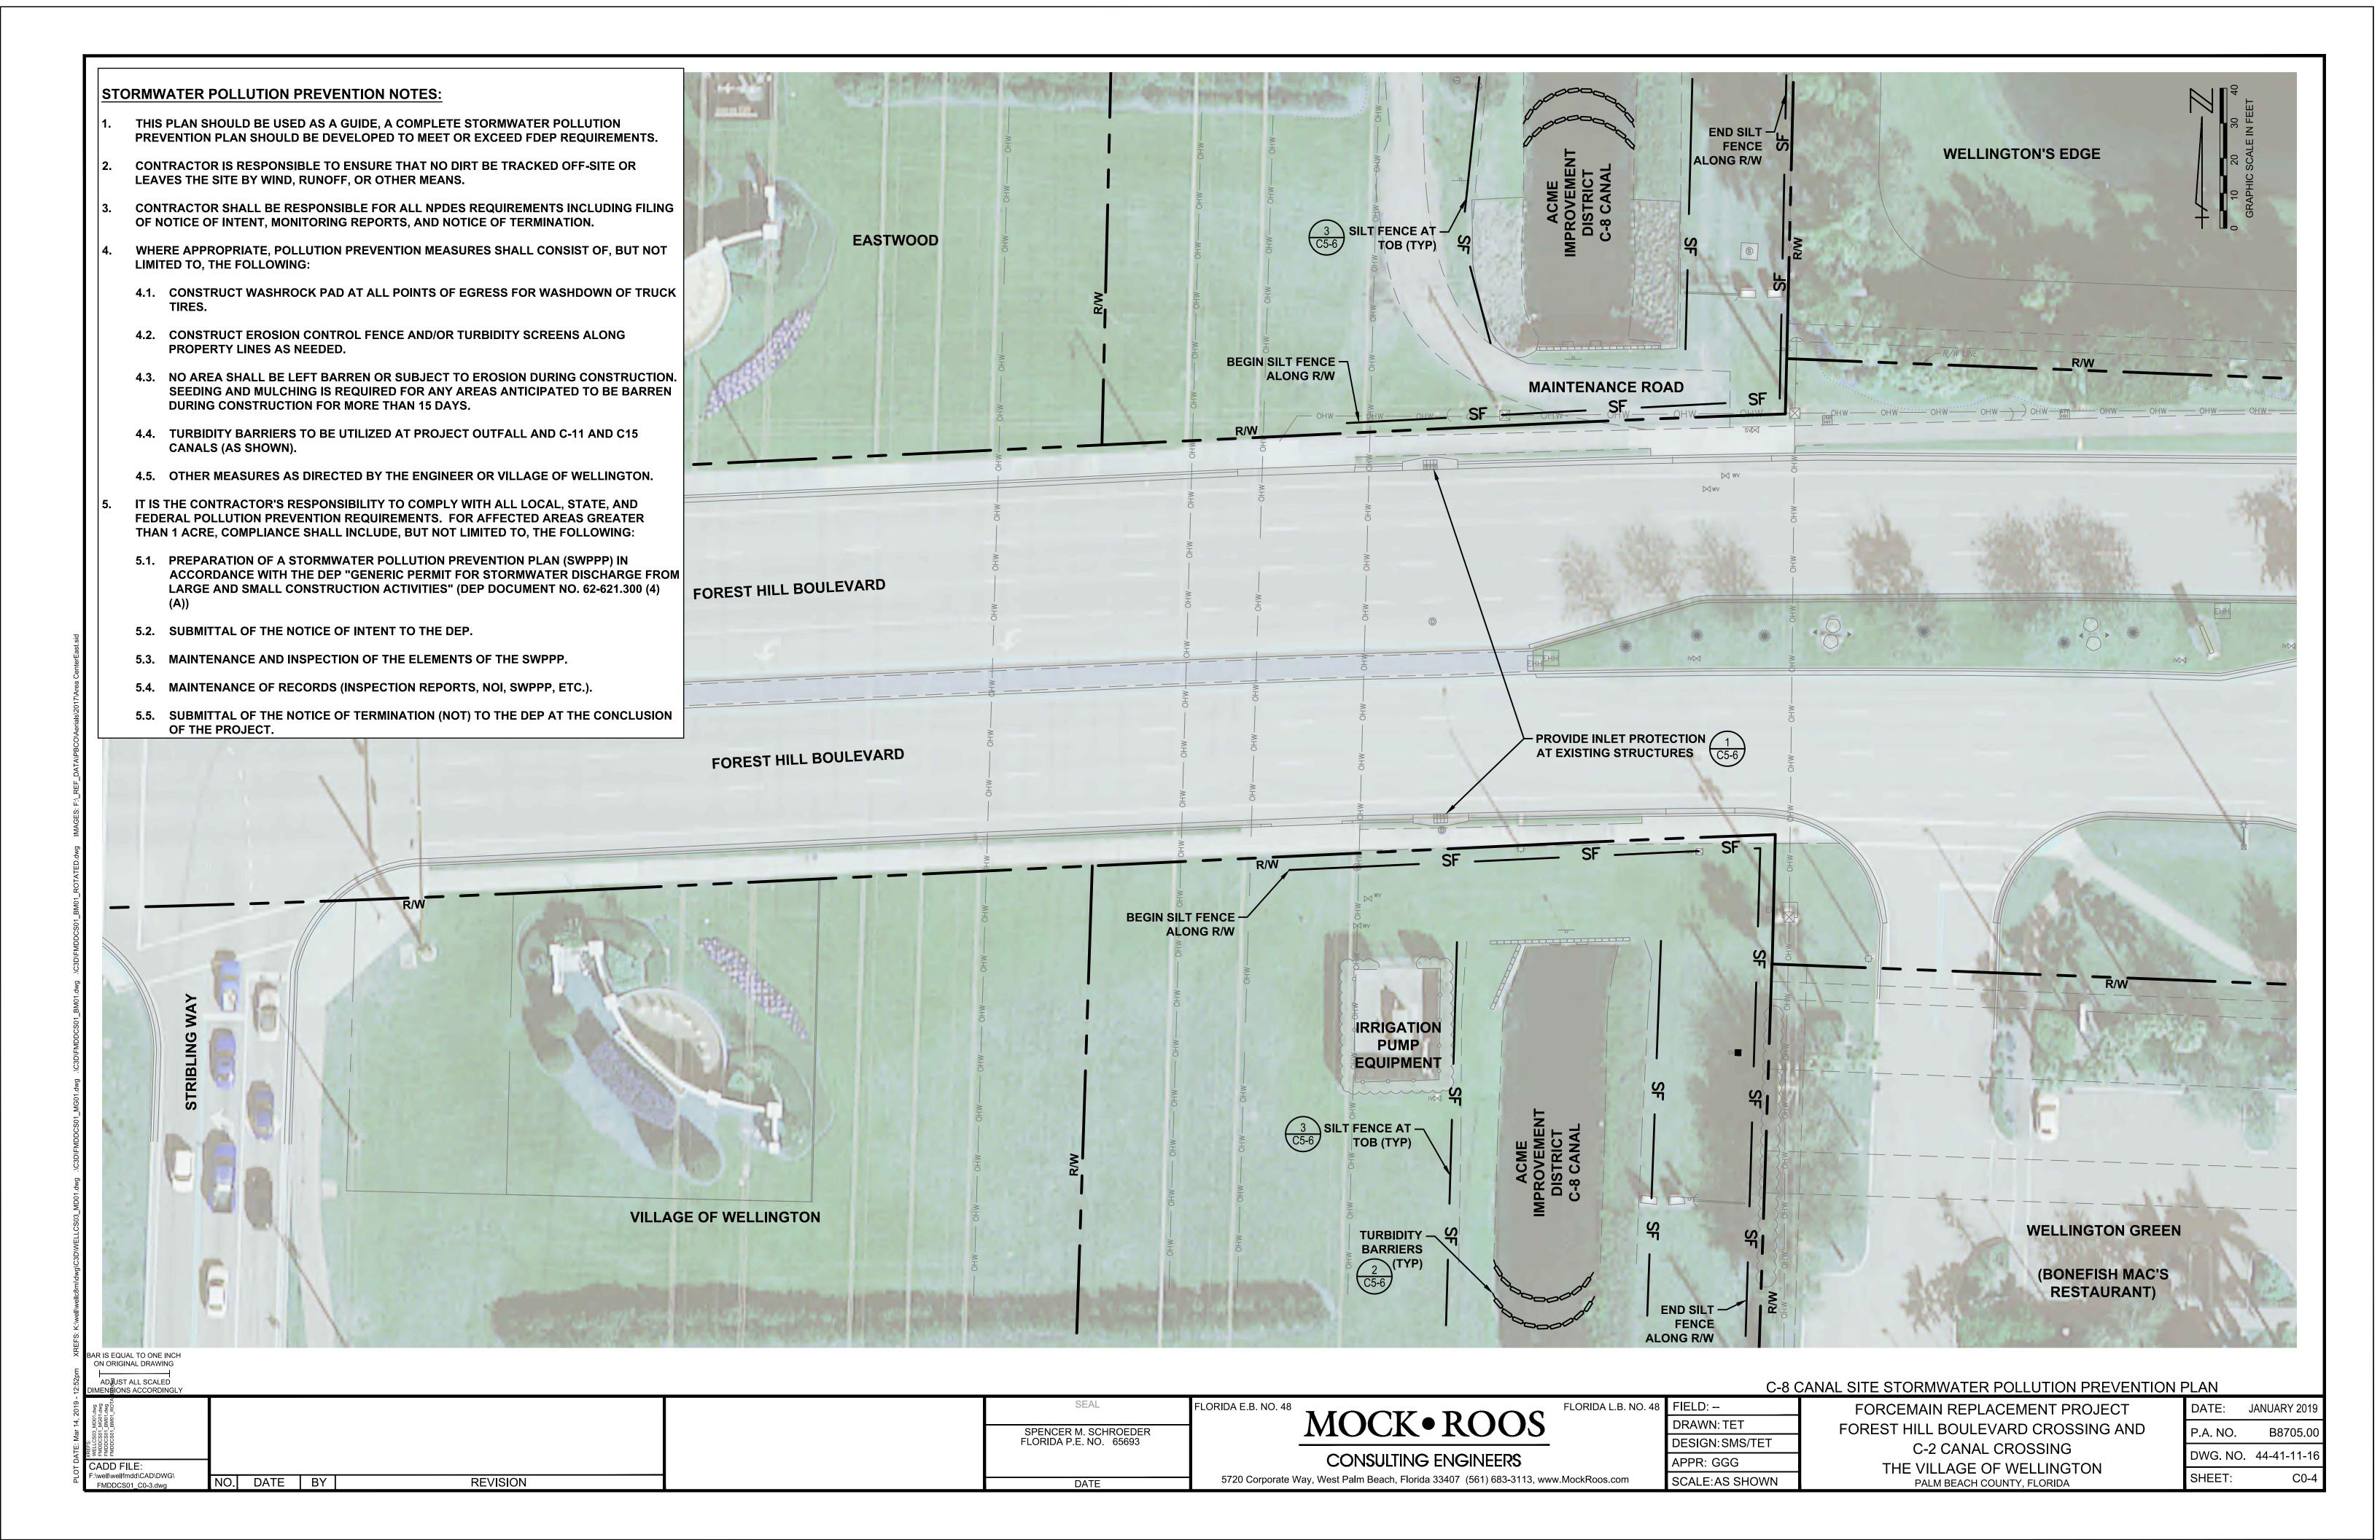


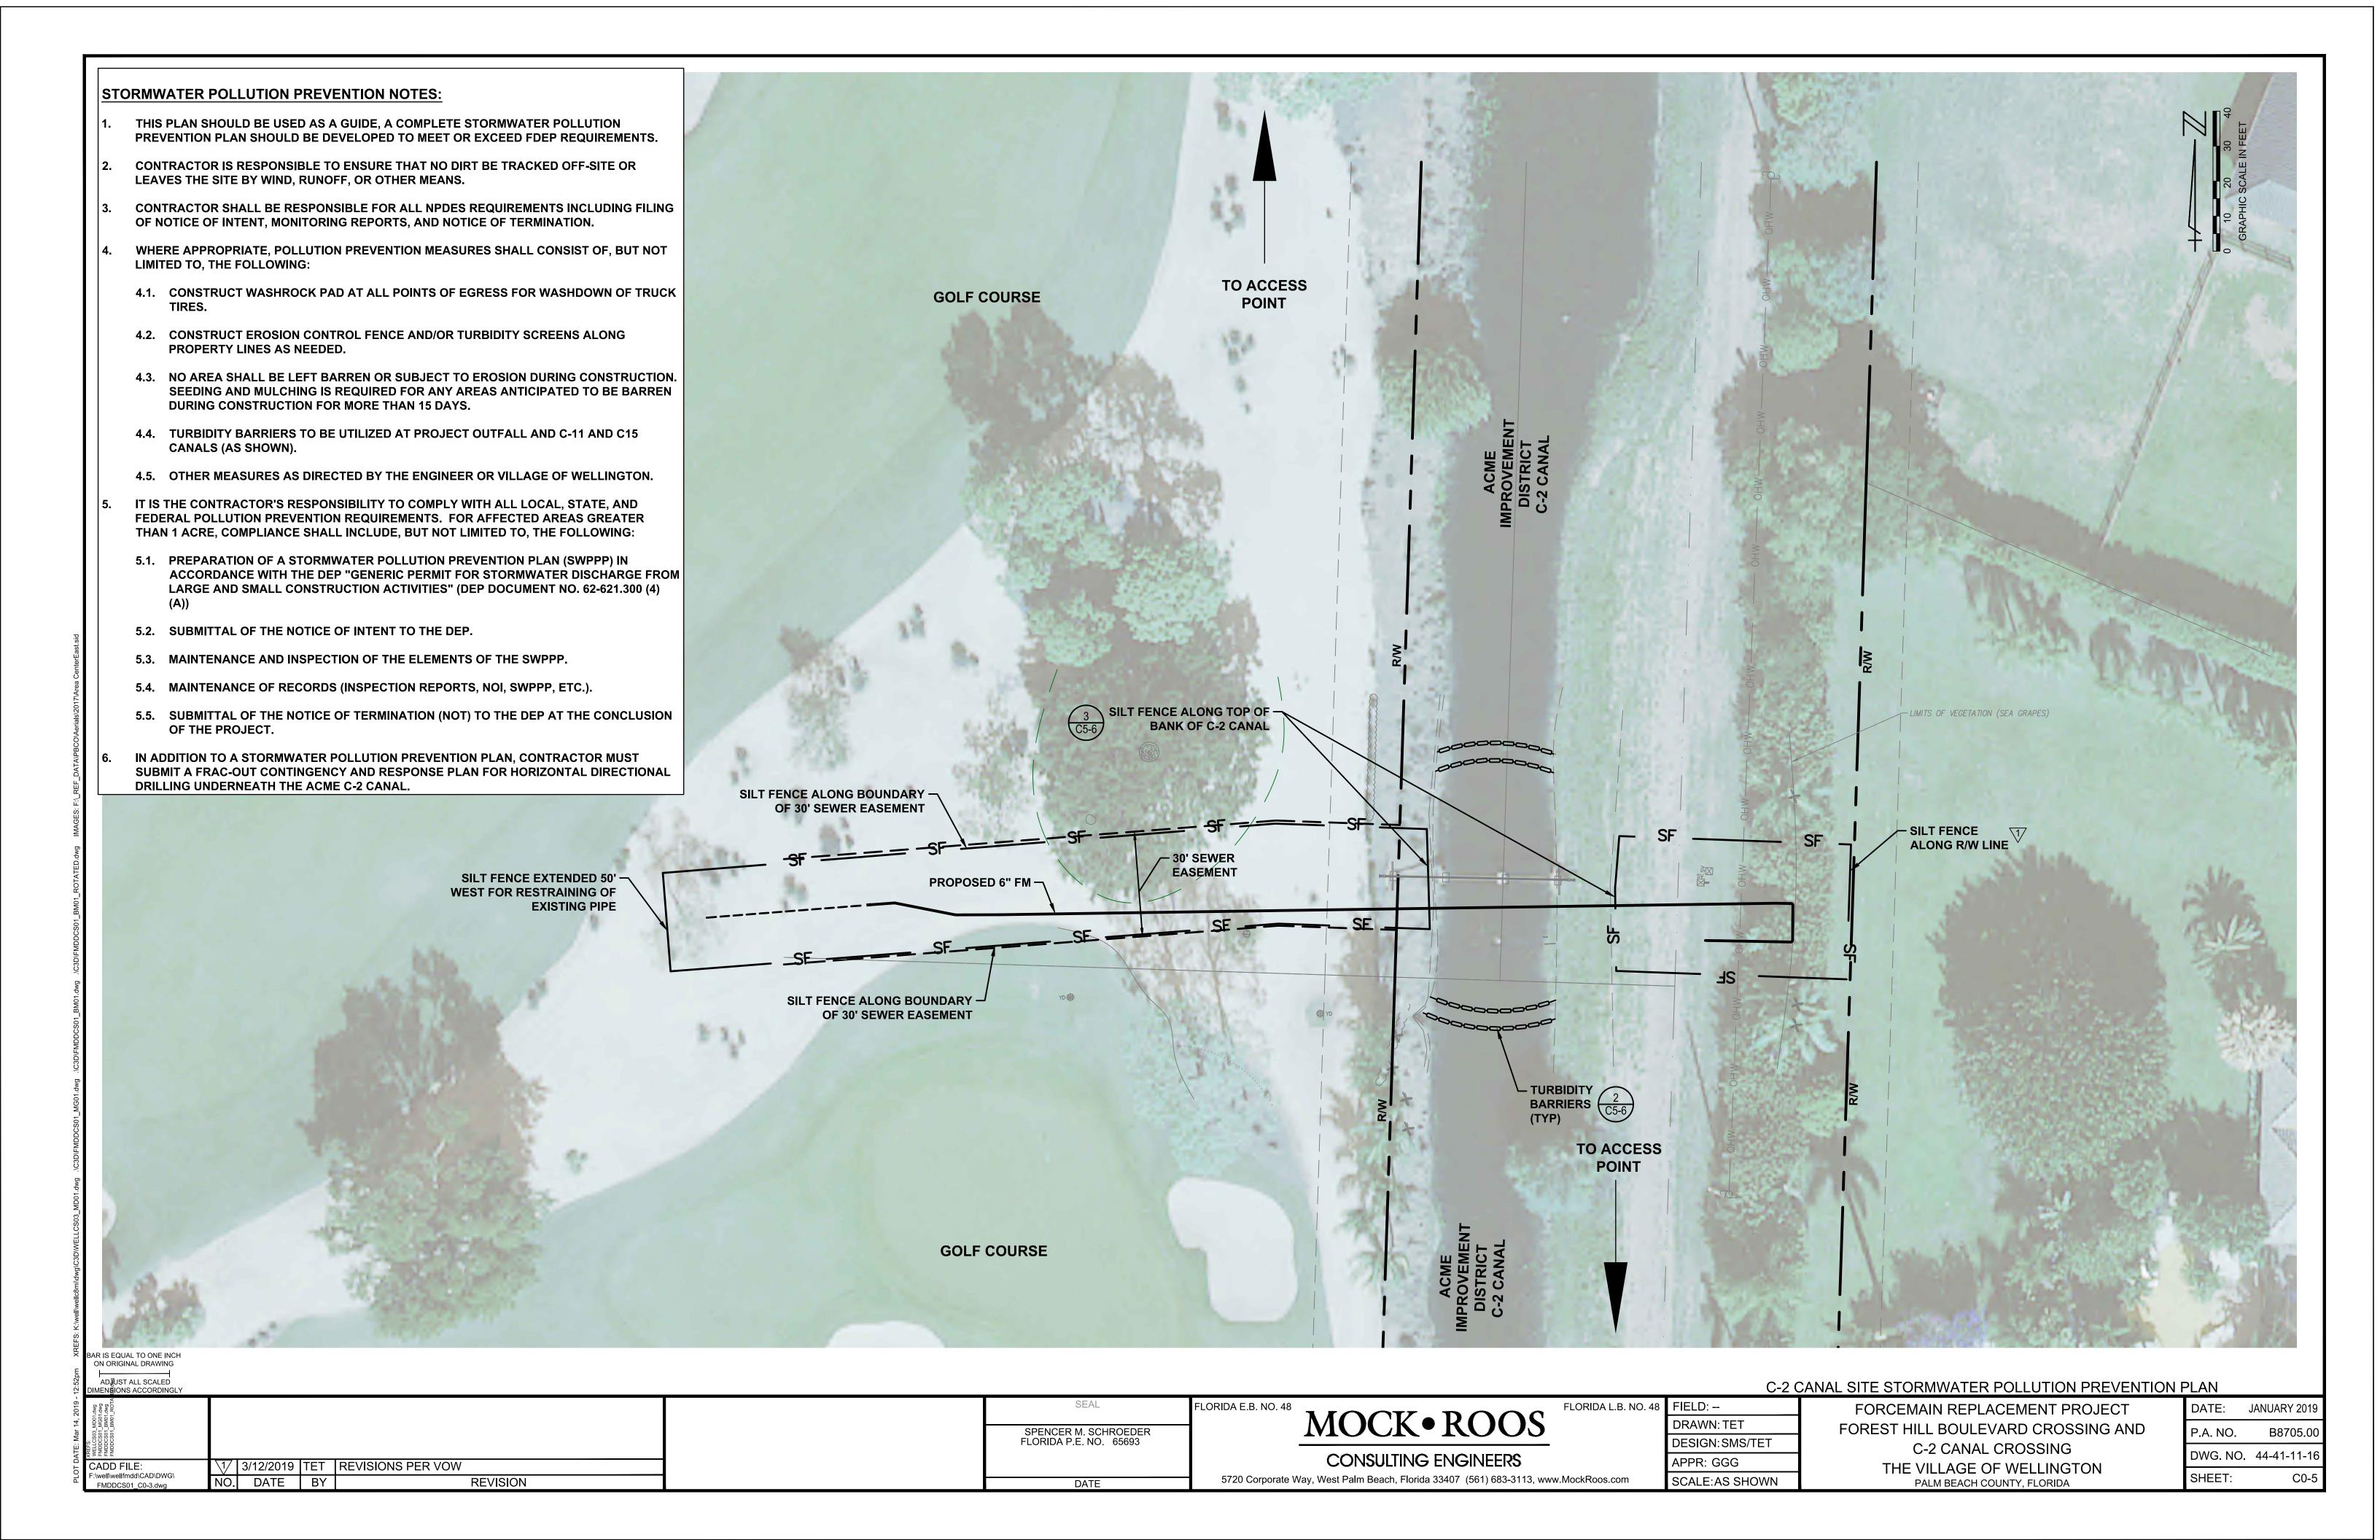

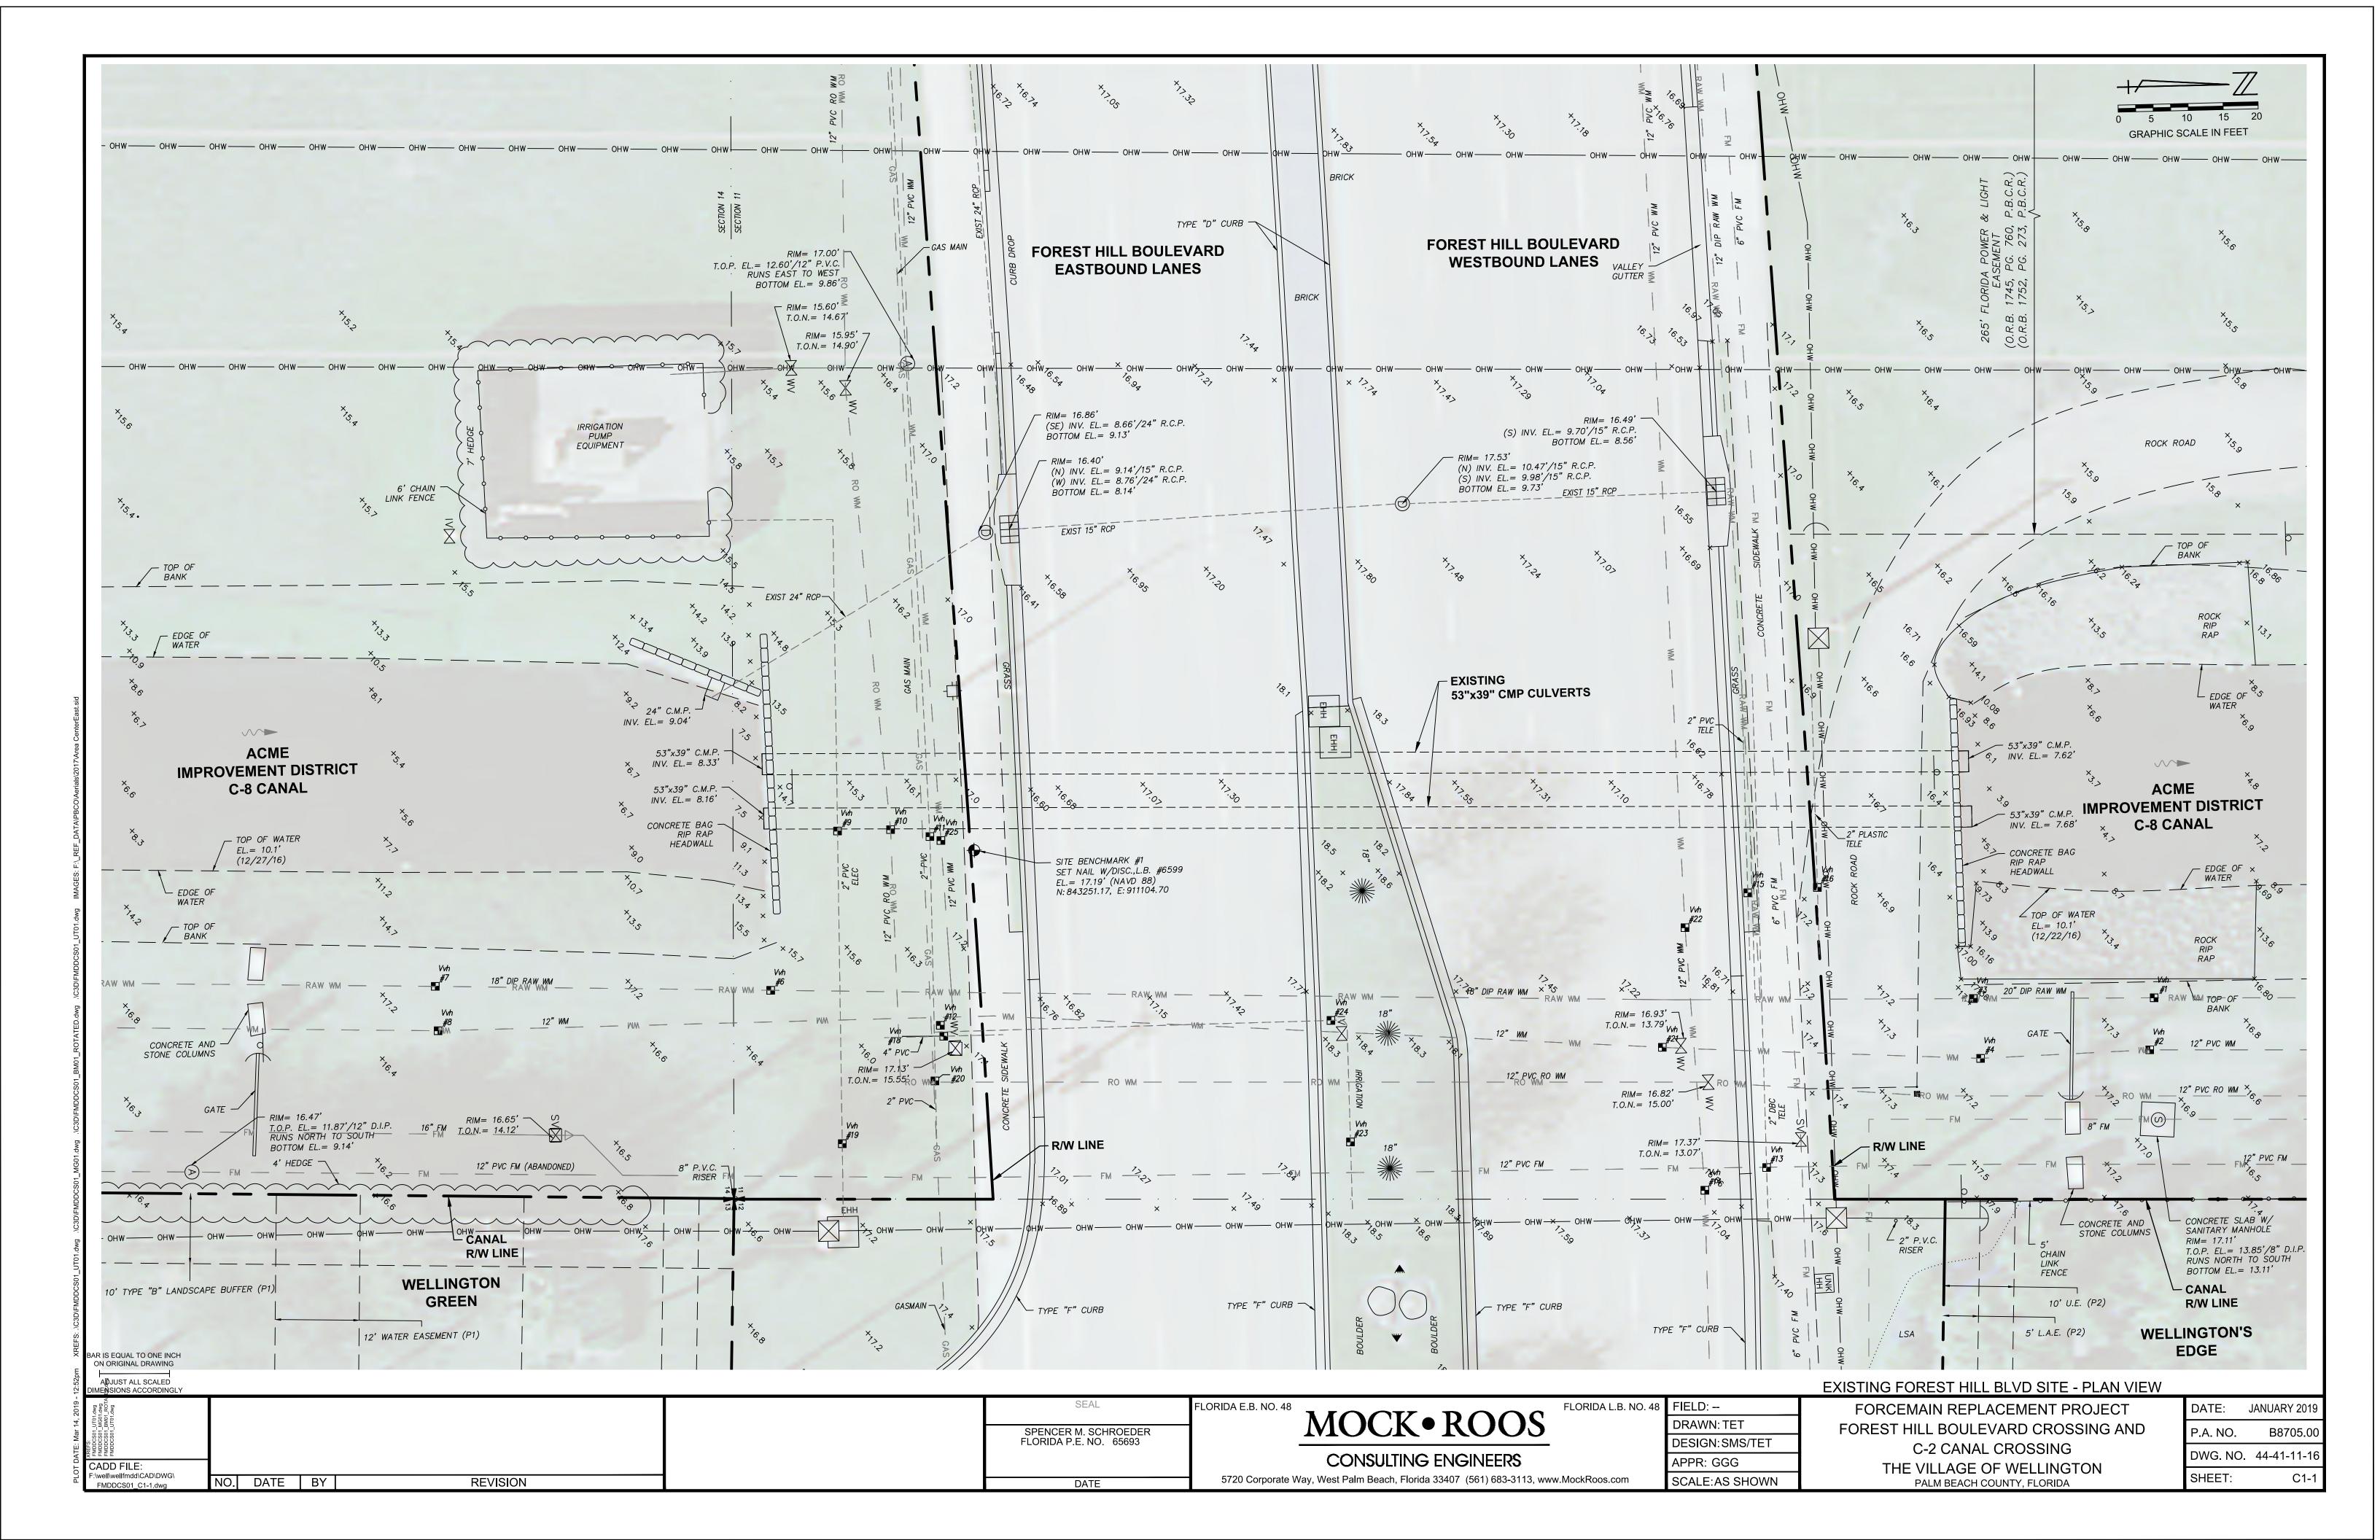

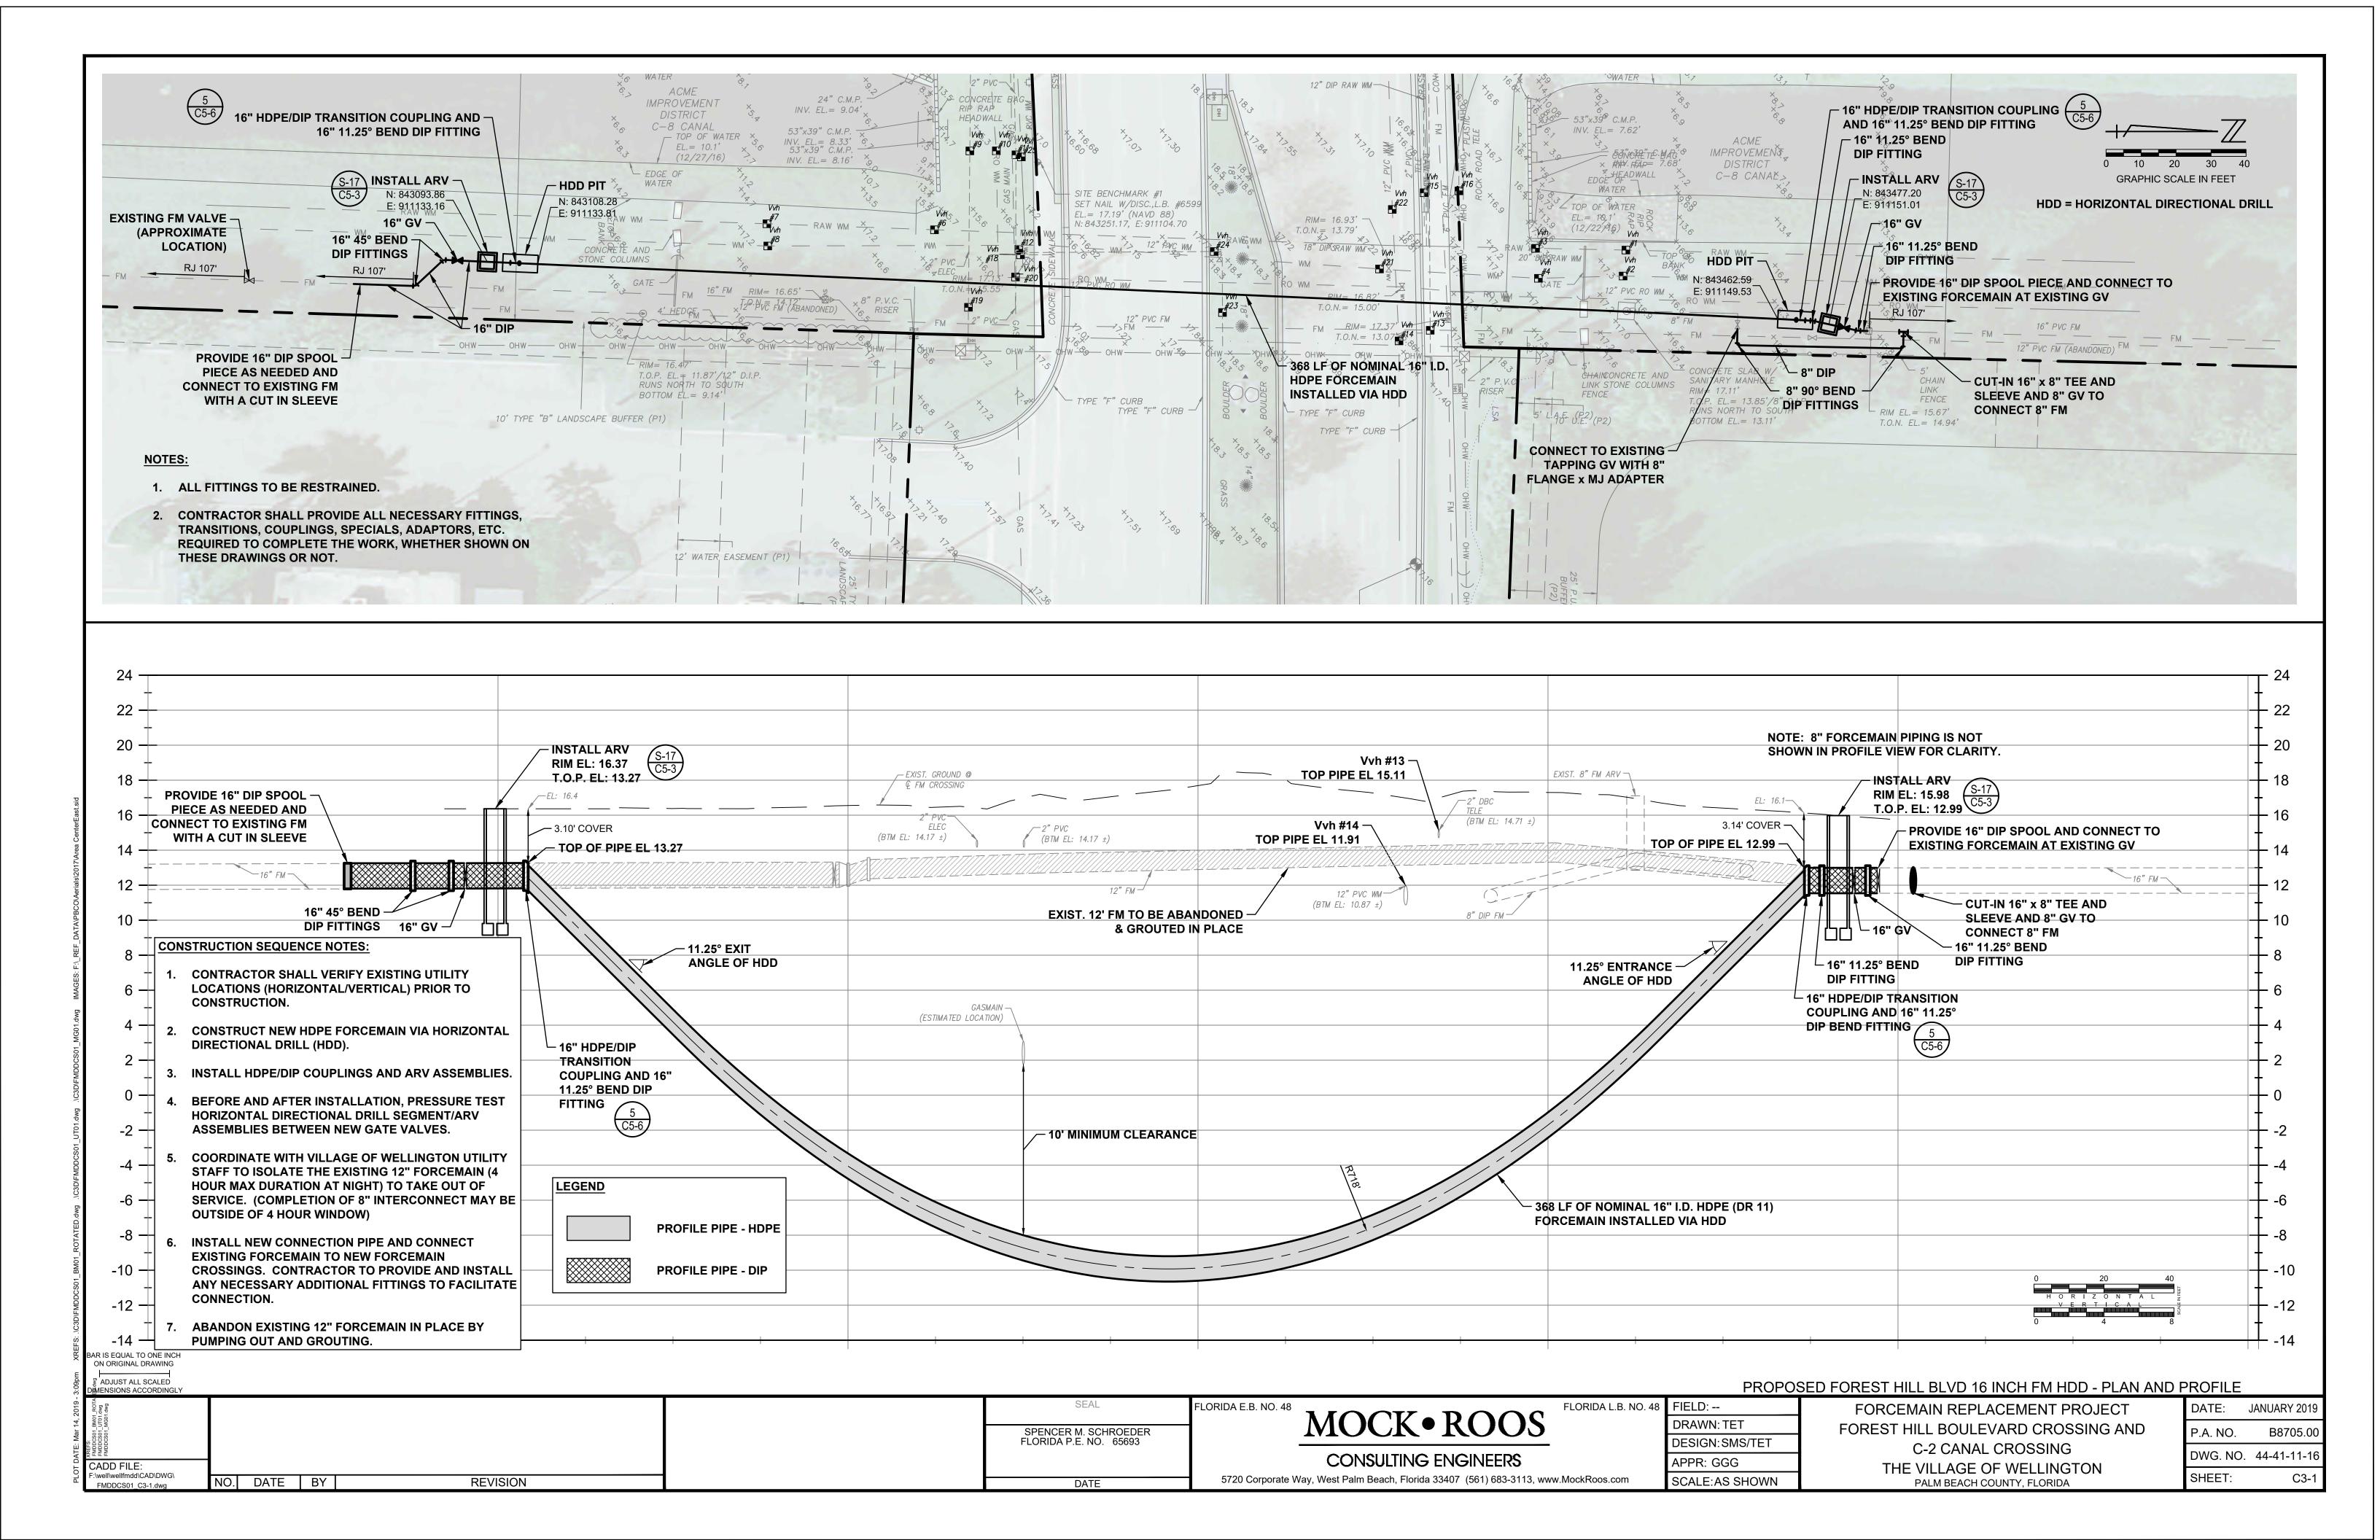

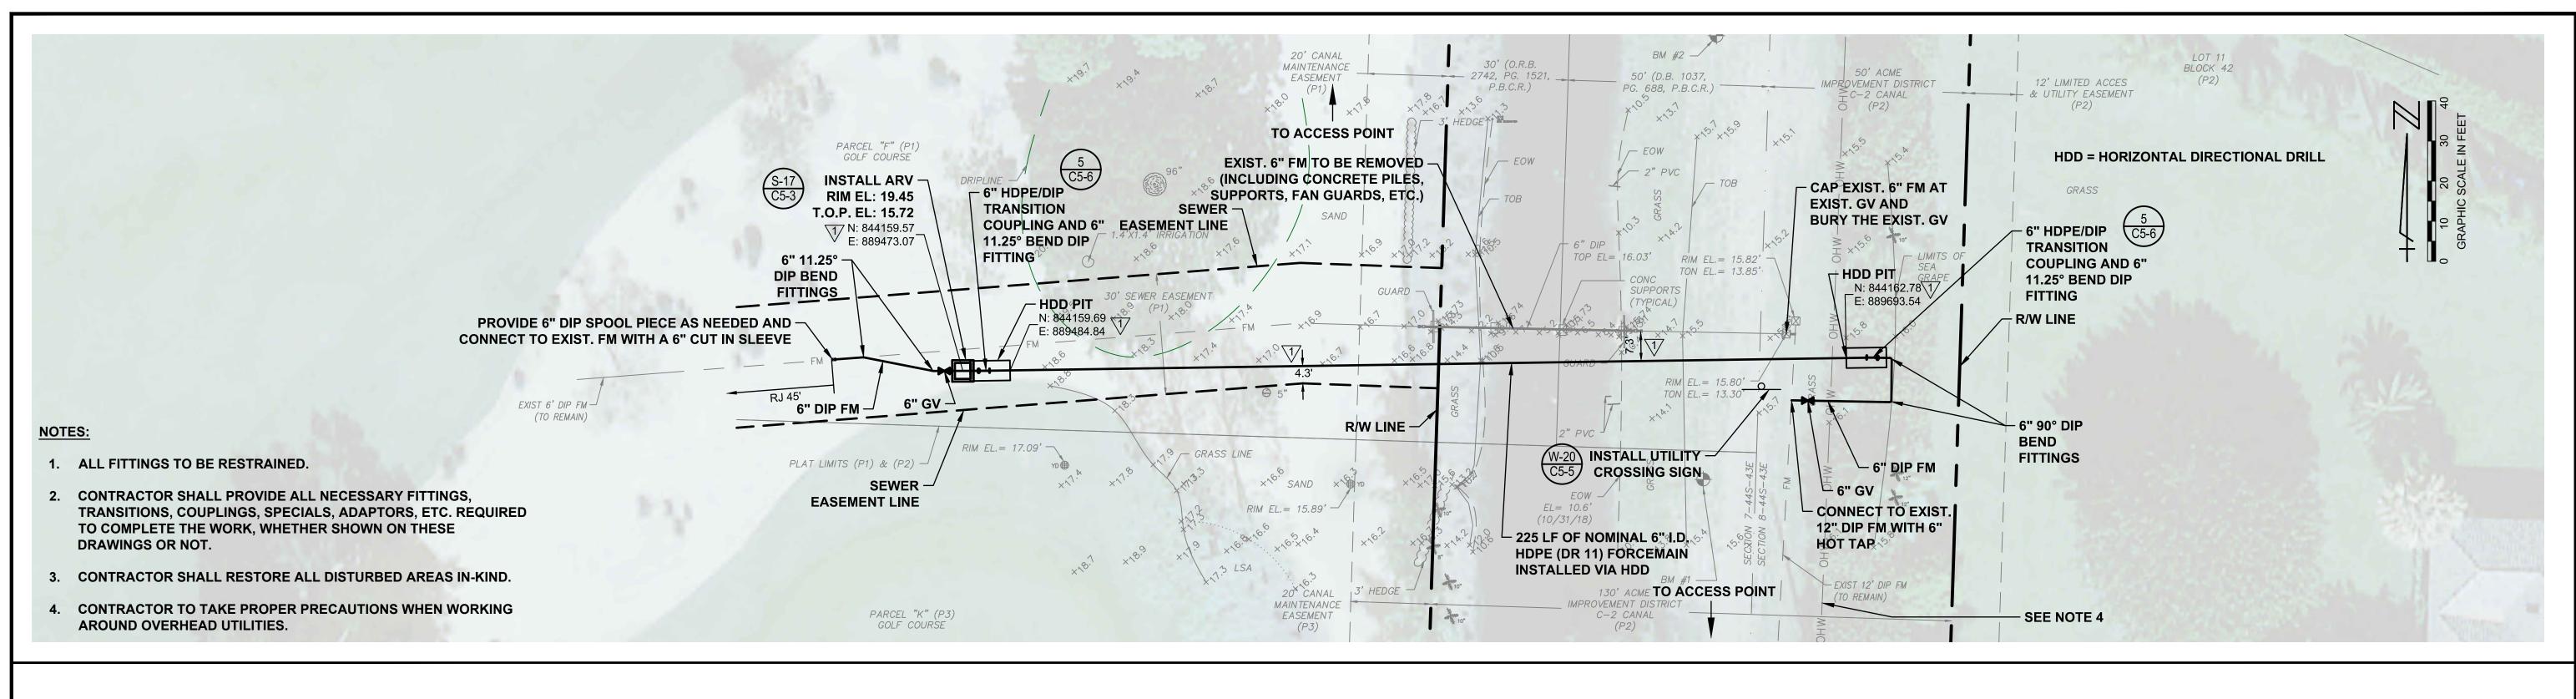

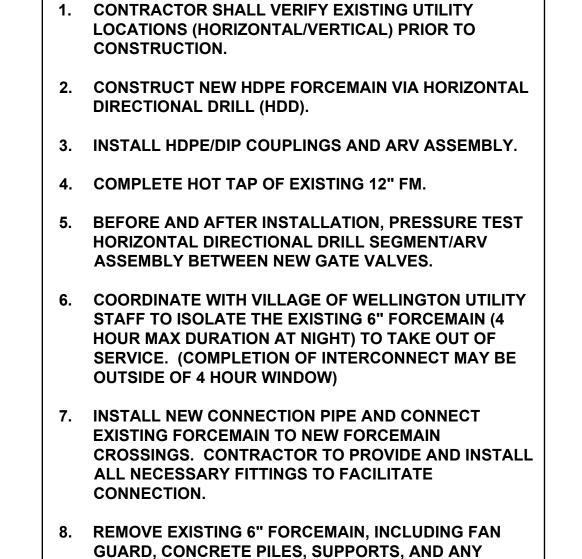

OTHER ELEMENTS OF THE EXISTING AERIAL

1/ 3/12/2019 | TET | REVISIONS PER VOW

REVISION

NO. DATE BY


CROSSING.

BAR IS EQUAL TO ONE INCH ON ORIGINAL DRAWING

CADD FILE:

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CONSTRUCTION SEQUENCE NOTES:

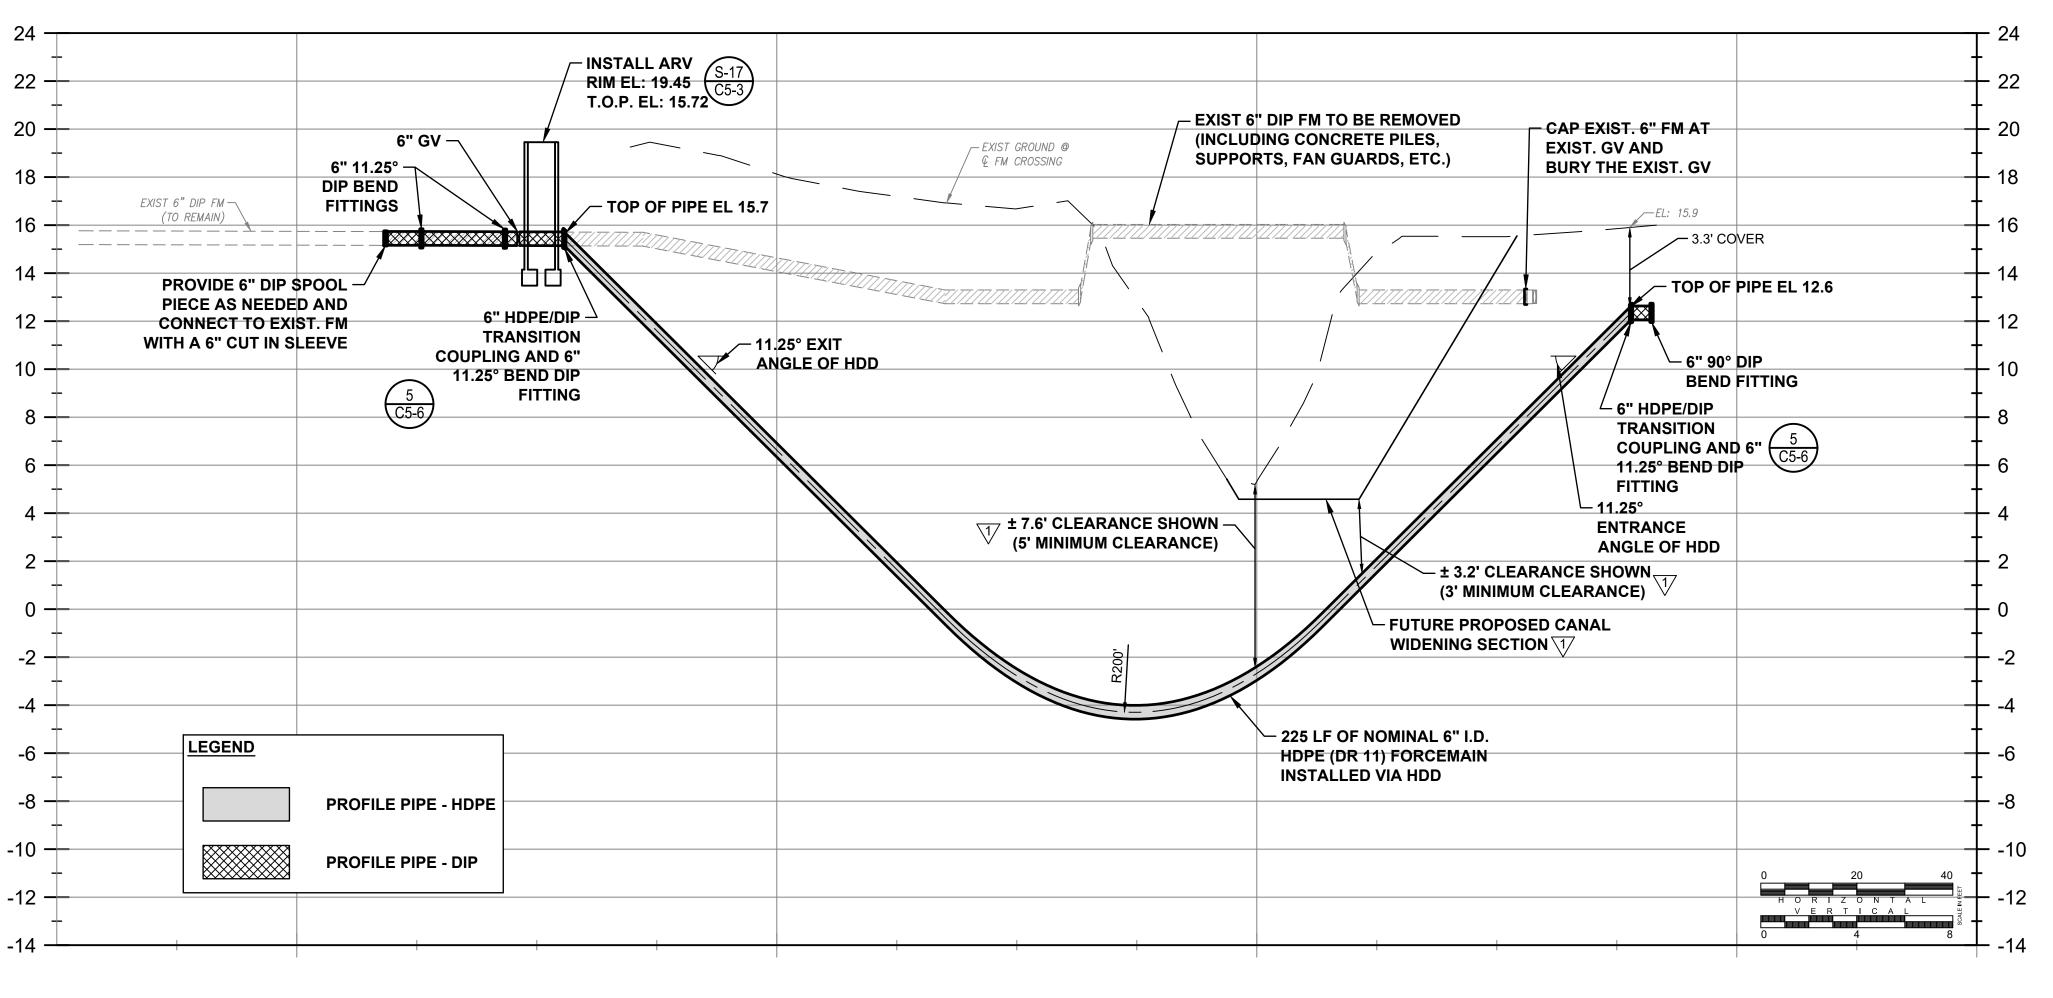

5720 Corporate Way, West Palm Beach, Florida 33407 (561) 683-3113, www.MockRoos.com

ADJUST ALL SCALED MENSIONS ACCORDINGLY SEAL FLORIDA L.B. NO. 48 MOCK•ROOS SPENCER M. SCHROEDER FLORIDA P.E. NO. 65693 CONSULTING ENGINEERS

DATE

FIELD: --FORCEMAIN REPLACEMENT PROJECT DRAWN: TET FOREST HILL BOULEVARD CROSSING AND DESIGN: SMS/TET C-2 CANAL CROSSING APPR: GGG THE VILLAGE OF WELLINGTON

SCALE: AS SHOWN

PROPOSED C-2 CANAL 6 INCH FM HDD - PLAN AND PROFILE

PALM BEACH COUNTY, FLORIDA

DATE: JANUARY 2019 B8705.00 P.A. NO. DWG. NO. 44-41-11-16 SHEET: C3-2

- 1. THE CONTRACTOR SHALL HAVE AVAILABLE AT THE JOB SITE AT ALL TIMES ONE (1) COPY OF THE CONTRACT DOCUMENTS, INCLUDING PLANS, SPECIFICATIONS AND COPIES OF ALL REQUIRED CONSTRUCTION PERMITS.
- 2. THE CONTRACTOR SHALL CONTACT ALL CONCERNED UTILITIES AT LEAST 48 HOURS IN ADVANCE OF CONSTRUCTION OPERATIONS.
- 3. THE LOCATION AND SIZE OF ALL EXISTING UTILITIES SHOWN ON THE PLANS ARE APPROXIMATE AND ARE BASED ON THE BEST AVAILABLE INFORMATION. THE CONTRACTOR SHALL BE RESPONSIBLE FOR LOCATION OF ALL EXISTING UTILITIES. THE CONTRACTOR SHALL VERIFY ALL UTILITIES BY ELECTRONIC METHOD AND BY HAND EXCAVATION IN COORDINATION WITH ALL UTILITY COMPANIES PRIOR TO BEGINNING ANY CONSTRUCTION OPERATIONS. ANY AND ALL CONFLICTS OF EXISTING UTILITIES WITH PROPOSED IMPROVEMENTS SHALL BE RESOLVED BY THE ENGINEER AND THE VILLAGE PRIOR TO BEGINNING ANY CONSTRUCTION OPERATIONS. THIS WORK BY THE CONTRACTOR SHALL BE CONSIDERED INCIDENTAL TO THE CONTRACT AND NO ADDITIONAL COMPENSATION SHALL BE ALLOWED.
- 4. IT IS THE CONTRACTOR'S RESPONSIBILITY TO ENSURE HIS COMPLETE FAMILIARITY WITH THE PROJECT SITE AND ITS COMPONENTS TO INCLUDE SUBSURFACE CONDITIONS OF SOIL AND GROUNDWATER TABLE. BY SUBMITTAL OF A BID FOR THIS PROJECT, THE CONTRACTOR ACKNOWLEDGES HIS COMPLETE UNDERSTANDING AND RESPONSIBILITIES WITH RESPECT TO THE CONSTRUCTION ACTIVITIES REQUIRED UNDER THE SCOPE OF
- 5. THE CONTRACTOR IS RESPONSIBLE FOR THE PROTECTION AND RESTORATION (IF DAMAGED) OF ALL EXISTING STRUCTURES WITHIN THE CONSTRUCTION LIMITS OF THE PROJECT, INCLUDING BUT NOT LIMITED TO; WALLS, FENCES, POWER POLES, MAIL BOXES, DRAINAGE STRUCTURES, LANDSCAPING, ETC.
- 6. PRIOR TO COMMENCEMENT OF CONSTRUCTION, THE CONTRACTOR SHALL NOTIFY THE FOLLOWING 48 HOURS
 - VILLAGE OF WELLINGTON
 - 2. FLORIDA POWER & LIGHT
 - 4. COMCAST CABLE TV
 - 5. SUNSHINE STATE ONE CALL OF FLORIDA INC.
- 7. VILLAGE OF WELLINGTON (VOW) WRITTEN SPECIFICATIONS AND STANDARD DETAILS (LATEST EDITION) ARE TO BE CONSIDERED PART OF THIS PROJECT AND CONSTRUCTION SHALL BE ENFORCED TO AT LEAST THESE MINIMUM STANDARDS.
- 8. ALL MATERIAL MUST CONFORM TO APPROVED SHOP DRAWINGS. ANY CHANGES MUST BE APPROVED BY ENGINEER AND VOW PRIOR TO INSTALLATION. FAILURE OF THE INSPECTOR TO CALL TO THE ATTENTION OF THE CONTRACTOR ANY ITEM NOT IN CONFORMANCE WITH PLANS AND SPECS SHALL NOT CONSTITUTE ACCEPTANCE OF THE ITEM.
- 9. VOW REPRESENTATIVES SHALL BE PRESENT DURING ALL OPERATIONS INVOLVING EXISTING UTILITIES.
- 10. NO CONCRETE THRUST BLOCKS WILL BE ALLOWED. ALL JOINTS SHALL BE MECHANICALLY RESTRAINED AS REQUIRED BY THE APPROVED PLANS.
- 11. SERVICE INTERRUPTIONS REQUIRE MINIMUM OF TWO (2) WEEKS PRIOR NOTIFICATION.
- 12. ALL PIPING MUST BE INSTALLED DRY.

OCT. 2018

NO. DATE BY


V.O.W. CONSTRUCTION STANDARDS & DETAILS PAGE No. REVISION GENERAL CONSTRUCTION NOTES (WASTEWATER) S-1

REVISION

- A. MINIMUM COVER SHALL BE 36 INCHES FROM FINISH GRADE. B. MINIMUM COVER UNDER DITCH SHALL BE 2' AND CANAL BOTTOMS SHALL BE 5' BELOW THE TYPICAL DESIGN SECTION.
- C. MAXIMUM COVER SHALL BE 42 INCHES FROM FINISHED GRADE.
- 14. C-900 PVC DR 18 MIN. SHALL BE REQUIRED IN THE FOLLOWING CIRCUMSTANCES (GRAVITY SEWER): A. WHEN A SEWER LINE PASSES OVER OR UNDER ANY OTHER PIPE OR CABLE WITH LESS THAN 12 INCHES CLEARANCE (A MINIMUM OF 6 INCHES OF CLEARANCE MUST BE MAINTAINED).
- C. WHEN MAKING CONNECTION FOLLOWING CORE DRILLING A MANHOLE.
- D. INSIDE DROP MANHOLE PIPING.
- E. WHEN GRAVITY SEWER IS LESS THAN 4.5' COVER TO THE INVERT OF THE PIPE. 4.5' OF COVER IS MINIMUM STANDARD COVER, LESS THAN 4.5' WILL NOT BE ACCEPTED UNLESS APPROVED BY THE UTILITY DIRECTOR.
- F. WHEN IN WELLFIELDS AS PER VILLAGE STANDARDS.
- 15. DIP SHALL BE REQUIRED IN THE FOLLOWING CIRCUMSTANCES (FORCE MAIN OR GRAVITY MAIN):
- A. WHEN PIPE RUNS THROUGH A STRUCTURE FOR AN ARV INSTALLATION.
- B. THE LAST RUN OF GRAVITY SEWER FROM THE TERMINAL MANHOLE TO THE LIFT STATION WET WELL. THIS SECTION OF PIPE IS ALSO REQUIRED TO BE LINED PER THE APL.
- 16. MANHOLES SHALL BE COATED INSIDE AND OUTSIDE. OUTSIDE COATINGS SHALL INCLUDE SEAMS AND MASONRY WORK ON TOPS AND PIPING ENTERING / EXITING MANHOLE.
- 17. ALL GRAVITY SEWER LINES WILL BE INSPECTED AND TESTED IN ACCORDANCE WITH VOW STANDARDS.
- 18. PAVEMENT REPLACEMENT, INCLUDING CURB, GUTTERS AND STRIPING SHALL OCCUR WITHIN SEVEN (7) WORKING DAYS FOLLOWING COMPLETION OF OPEN CUT WORK.
- 19. TAPPING SLEEVES SHALL BE A MINIMUM OF THREE (3) FEET FROM A PIPE JOINT.
- 20. ALL EXPOSED (ABOVE GRADE) DUCTILE IRON FORCE MAIN SHALL BE COLOR CODED TNEMEC SAFETY GREEN.
- 21. ALL OPENINGS AND PIPING ENTERING / EXITING MANHOLE SHALL BE SEALED WITH WATERPROOF NON SHRINKING GROUT OR APPROVED EQUAL.
- 22. RUBBER BOOT CONNECTIONS MUST BE SECURED USING TWO (2) STAINLESS STEEL STRAPS.
- 23. ELECTRONIC SERVICE LOCATORS MUST BE SEWER (GREEN).
- 24. USE OF REPAIR SLEEVES AND OR REPAIR COUPLINGS IS PROHIBITED WITHOUT PRIOR APPROVAL
- 25. MAXIMUM DEPTH FROM FINISH GRADE TO INVERT OF SERVICE LATERAL WYE IS THREE (3) FEET UNLESS APPROVED BY VILLAGE UTILITY DIRECTOR.
- 26. LIFT STATION START UP WILL BE ACCOMPLISHED USING BOTH F.P.L. POWER AND EMERGENCY GENERATOR PROVIDED FOR PROJECT.
- 27. DROP MANHOLE INTERIOR RECIEVES THE SAME COATING REQUIREMENTS AS LIFT STATION INTERIORS.
- 28. MECHANICAL PLUG REQUIRED IN EXISTING MANHOLE TO PROTECT SYSTEM FROM CONTAMINATION. PLUG IS NOT TO BE REMOVED UNTIL PROJECT ACCEPTANCE. VIOLATION OF THIS COULD IN TURN REQUIRE INSPECTION AND CLEANING OF EXISTING SYSTEM BACK TO LIFT STATIONS.

V.O.W. CONSTRUCTION STANDARDS & DETAILS

PAGE No. REVISION GENERAL CONSTRUCTION NOTES (WASTEWATER) S-2 OCT. 2018

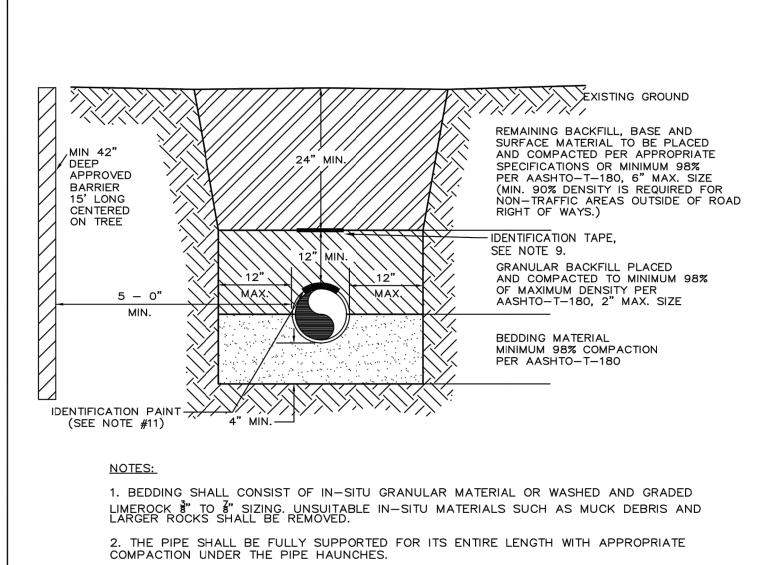

3. THE PIPE SHALL BE PLACED IN A DRY TRENCH.

SPECIFIED IN PERMIT/CONTRACT DOCUMENTS.

- 4. BACKFILL SHALL BE FREE OF UNSUITABLE MATERIAL SUCH AS LARGE ROCK, MUCK,
- 5. DENSITY TESTS ARE REQUIRED IN 1 FOOT LIFTS ABOVE THE PIPE AT INTERVALS OF 400' MAXIMUM. MINIMUM 1 SET SET OF TESTS FOR EACH GRAVITY MAIN RUN BETWEEN MANHOLES OR AS DIRECTED BY THE VILLAGE.
- 6. THE DEVELOPER/CONTRACTOR SHALL BE RESPONSIBLE TO COMPLY WITH ALL TRENCH SAFETY LAWS AND REGULATIONS.
- 7. SEE SEPERATE DETAIL FOR "PIPE INSTALLATION UNDER EXISTING PAVEMENT OPEN
- 8. THE AFFECTED AREA SHALL BE RESTORED TO EQUAL OR BETTER CONDITION OR AS
- 9. APPROVED MAGNETIC TAPE IS REQUIRED FOR ALL MAINS. THE TAPE SHALL BE
- INSTALLED 12" ABOVE PIPE. 10. ROOT BARRIER IS REQUIRED FOR APPROVED TREE INSTALLATION 10' OR CLOSER
- FROM UTILITY FACILITIES AS APPROVED BY THE DEPARTMENT.

11. CONTINUOUS 4" WIDE PAINT STRIPING IS REQUIRED FOR DIP SEWER MAINS (GREEN) AND DIP RECLAIMED WATER MAINS (PURPLE).

	V.O.W. CONSTRUCTION STANDARDS & DETAILS	
REVISION		_
	TYPICAL TRENCH DETAIL	

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SEAL SPENCER M. SCHROEDER FLORIDA P.E. NO. 65693

DATE

FLORIDA E.B. NO. 48 MOCK•ROOS

CONSULTING ENGINEERS

FIELD: --FLORIDA L.B. NO. 48 DRAWN: TET DESIGN: SMS/TET APPR: GGG SCALE: N/A

OCT. 2018

FORCEMAIN REPLACEMENT PROJECT FOREST HILL BOULEVARD CROSSING AND C-2 CANAL CROSSING THE VILLAGE OF WELLINGTON PALM BEACH COUNTY, FLORIDA


VILLAGE OF WELLINGTON STANDARD DETAILS

DATE: JANUARY 2019 B8705.00 P.A. NO. DWG. NO. 44-41-11-16 SHEET: C5-1


PAGE No.

S-3


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VILLAGE OF WELLINGTON STANDARD DETAILS

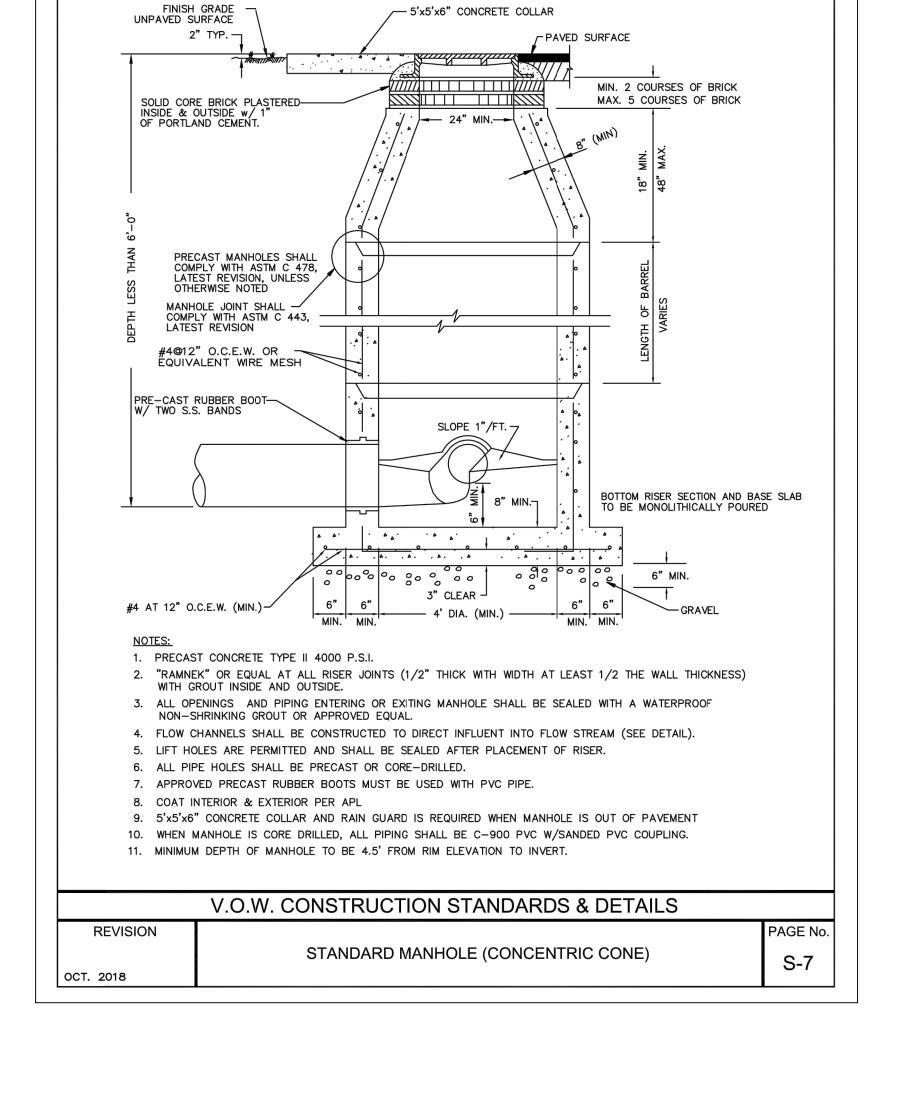FIELD: --

DRAWN: TET
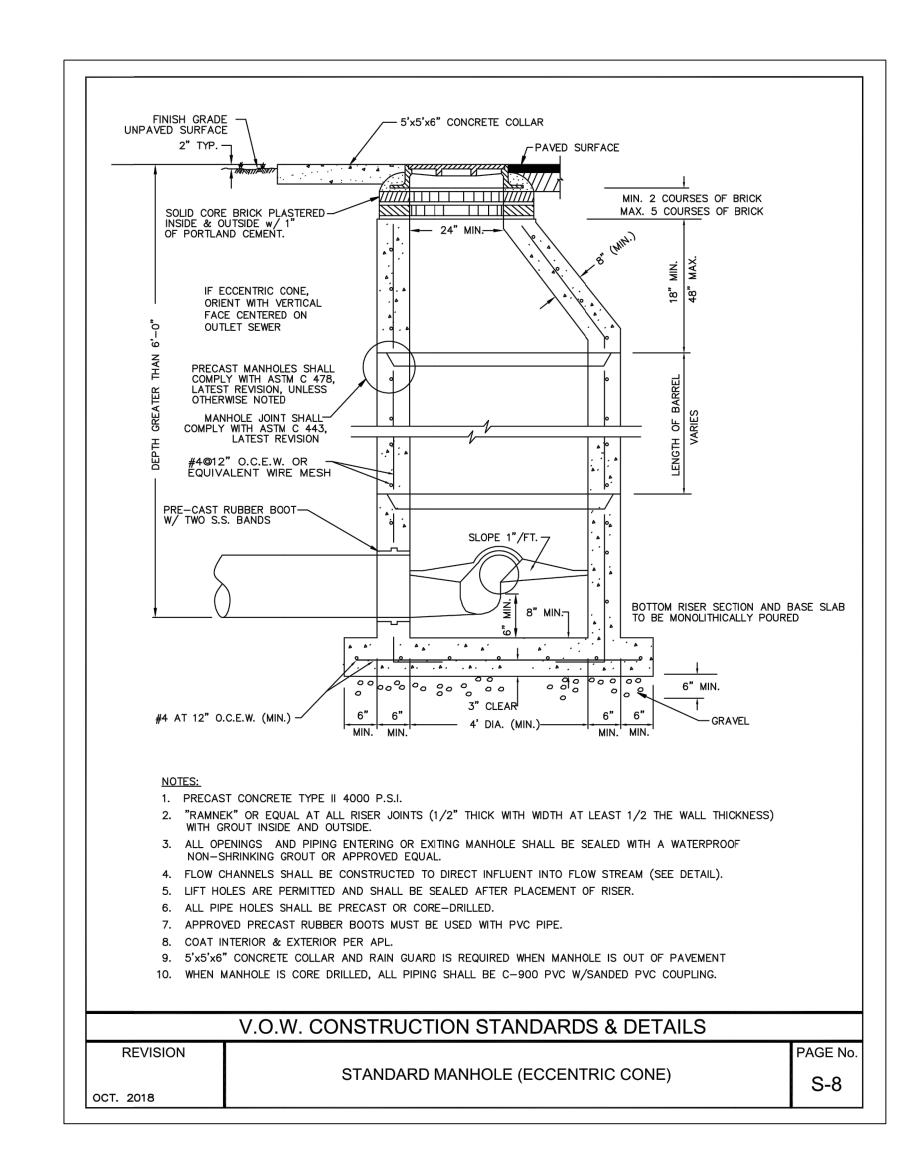
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FLORIDA L.B. NO. 48


FORCEMAIN REPLACEMENT PROJECT FOREST HILL BOULEVARD CROSSING AND C-2 CANAL CROSSING THE VILLAGE OF WELLINGTON

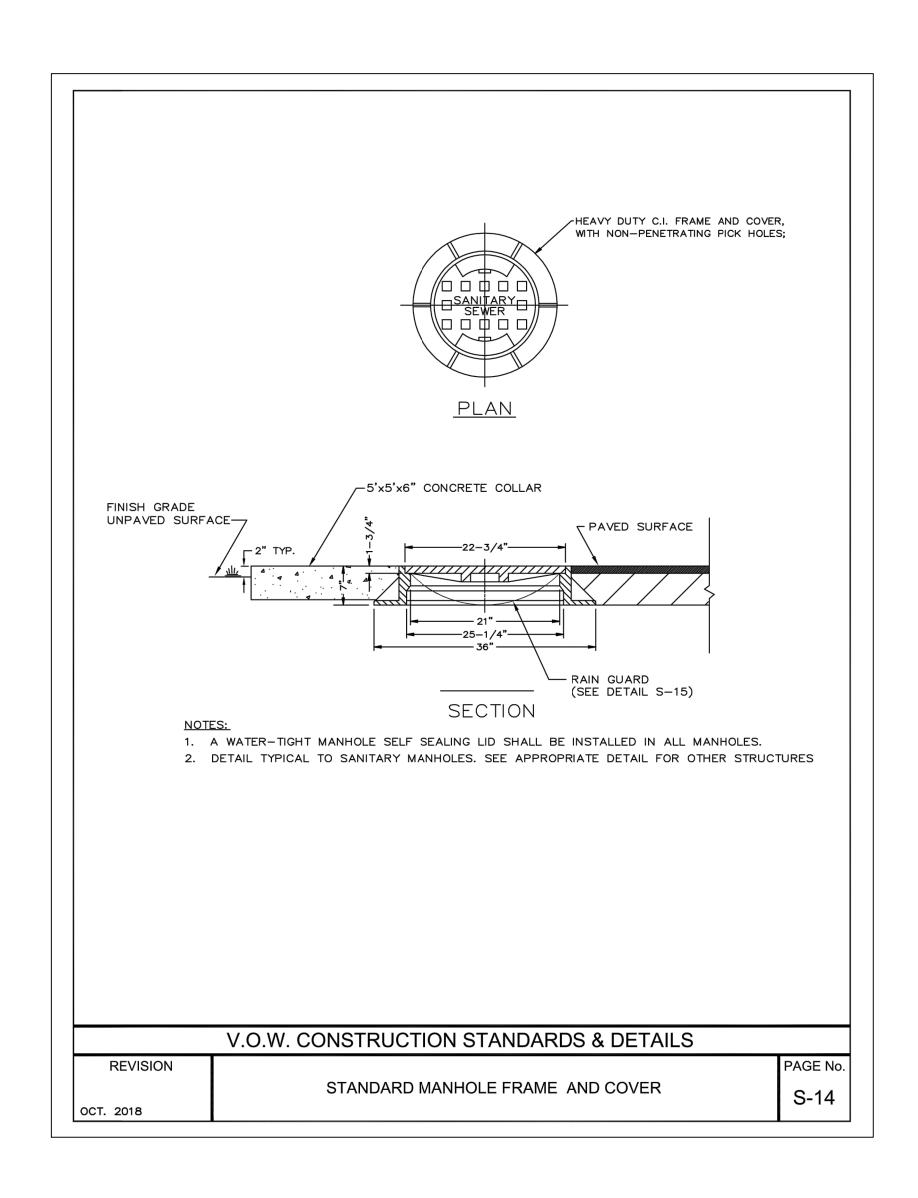PALM BEACH COUNTY, FLORIDA


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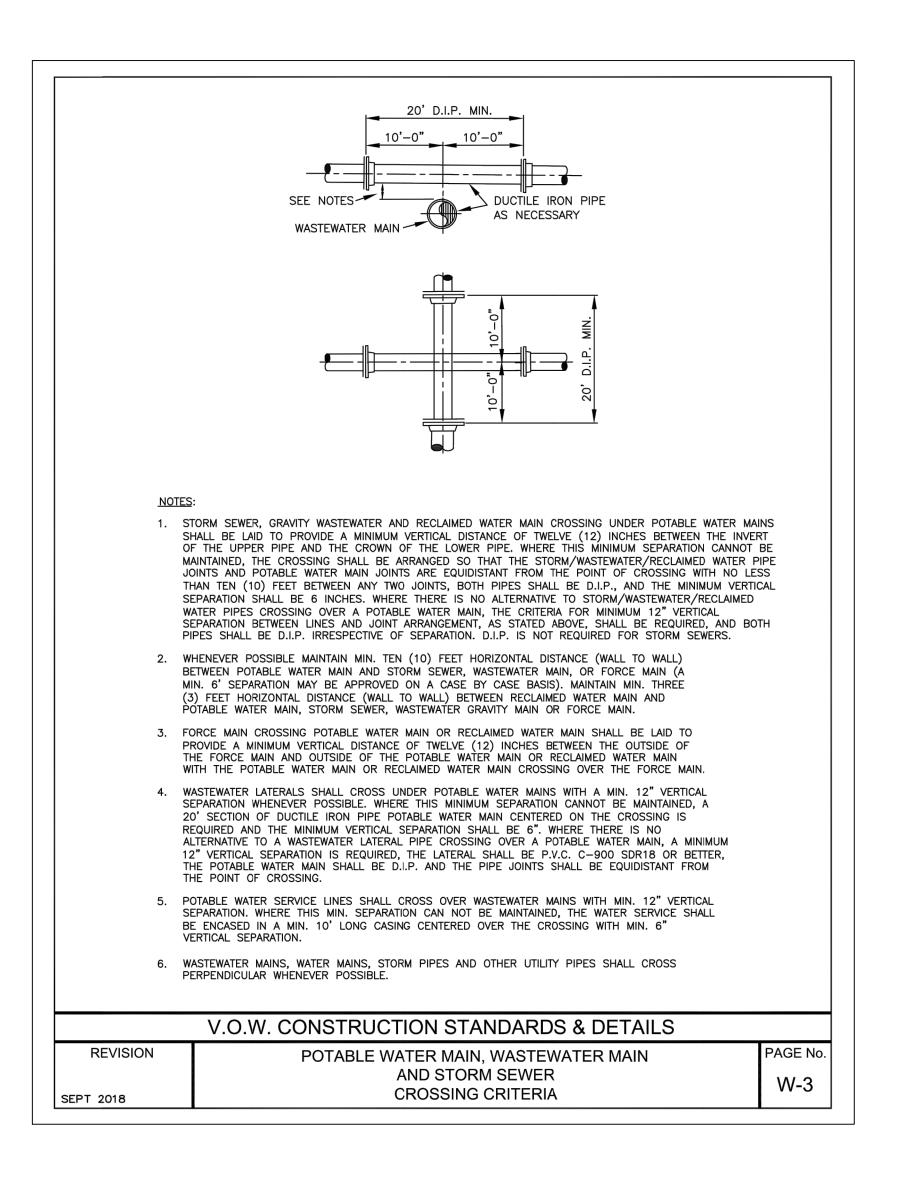
MOCK • ROOS SPENCER M. SCHROEDER FLORIDA P.E. NO. 65693 CONSULTING ENGINEERS DATE

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SEAL SPENCER M. SCHROEDER FLORIDA P.E. NO. 65693 DATE

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FLORIDA L.B. NO. 48

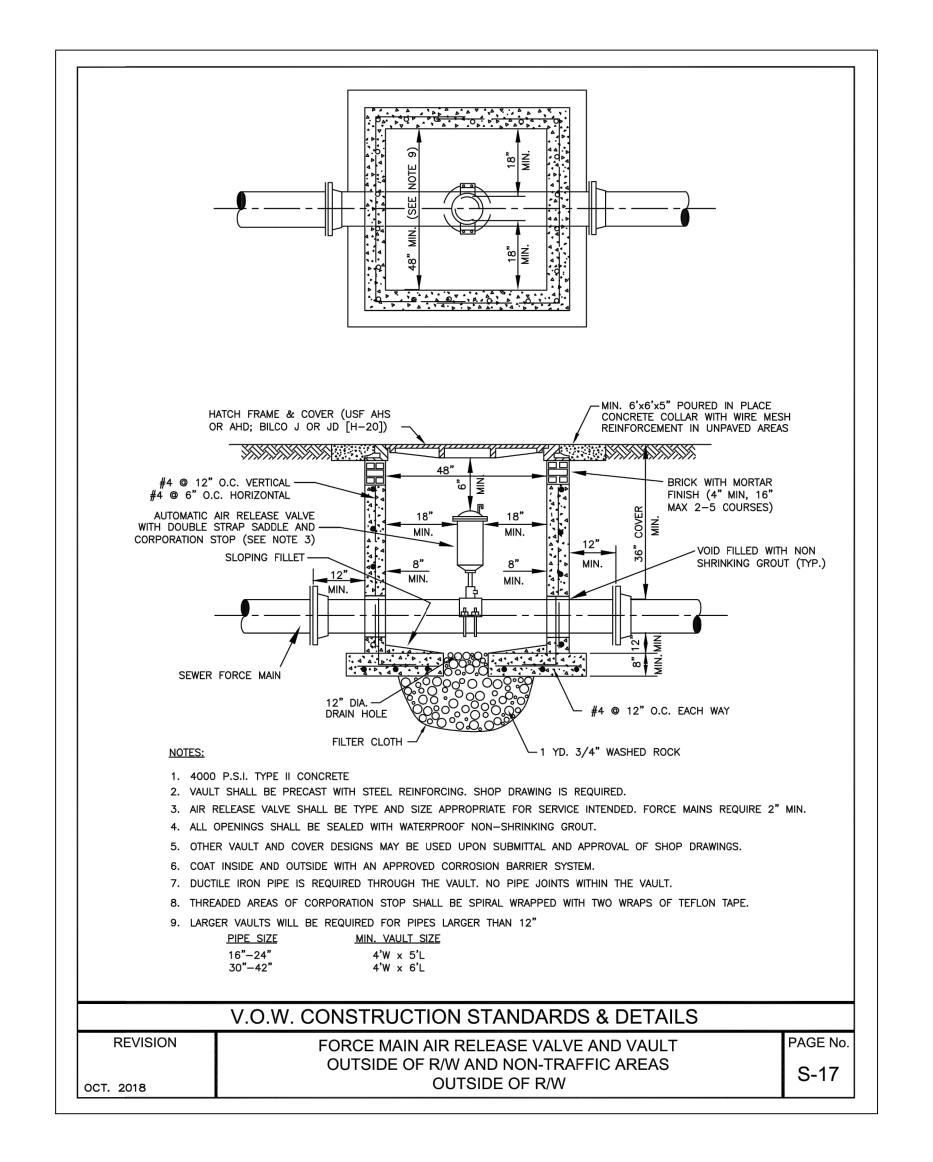
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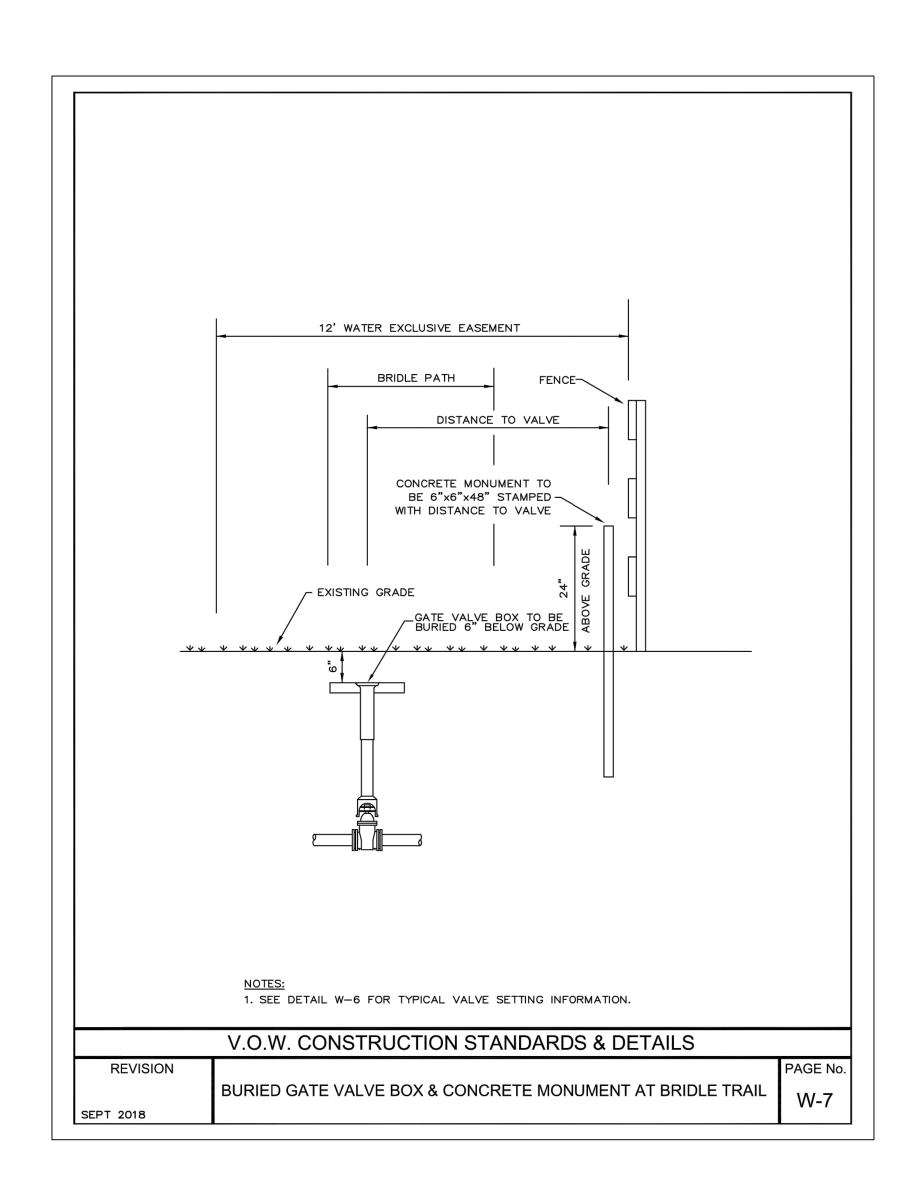
VILLAGE OF WELLINGTON STANDARD DETAILS PALM BEACH COUNTY, FLORIDA

FORCEMAIN REPLACEMENT PROJECT FOREST HILL BOULEVARD CROSSING AND C-2 CANAL CROSSING THE VILLAGE OF WELLINGTON

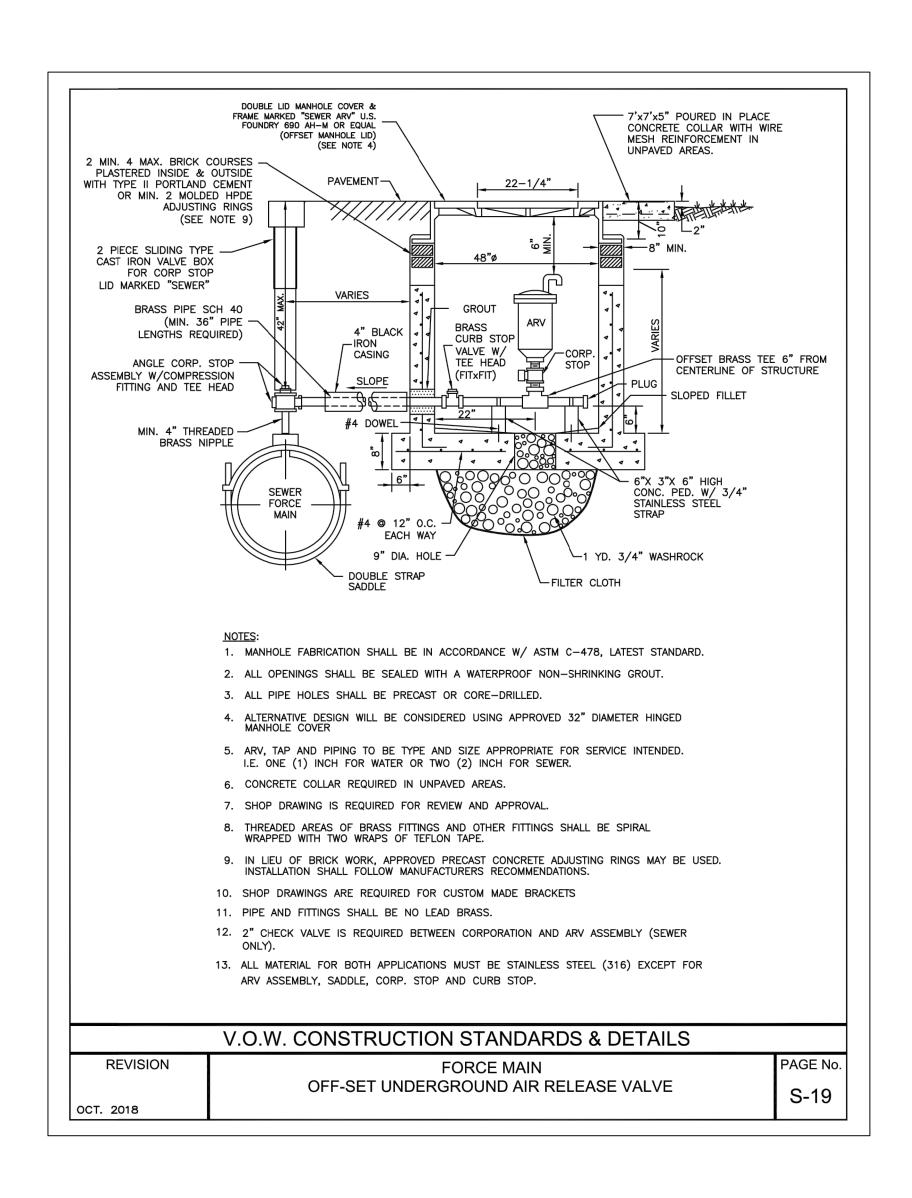
DATE: JANUARY 2019 B8705.00 P.A. NO. DWG. NO. 44-41-11-16 SHEET: C5-3



REVISION

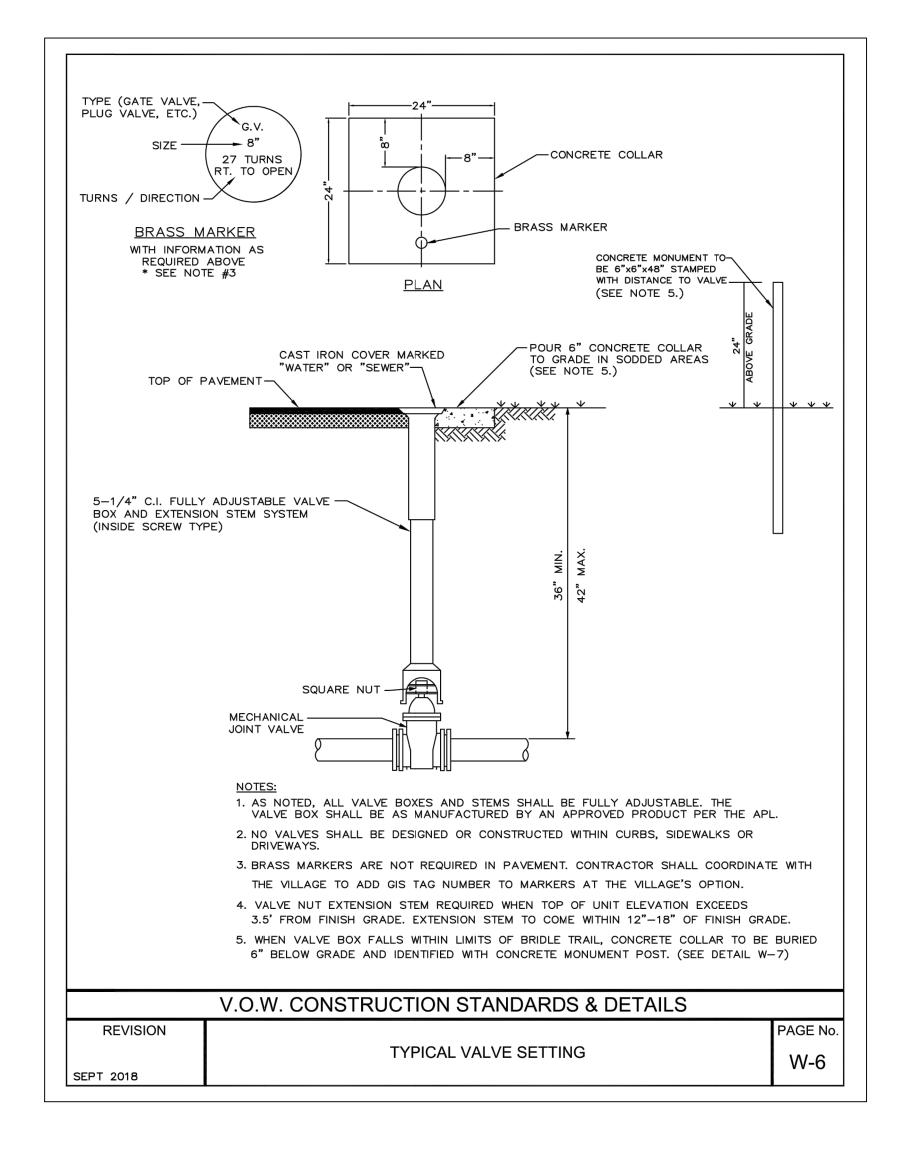

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VILLAGE OF WELLINGTON STANDARD DETAILS

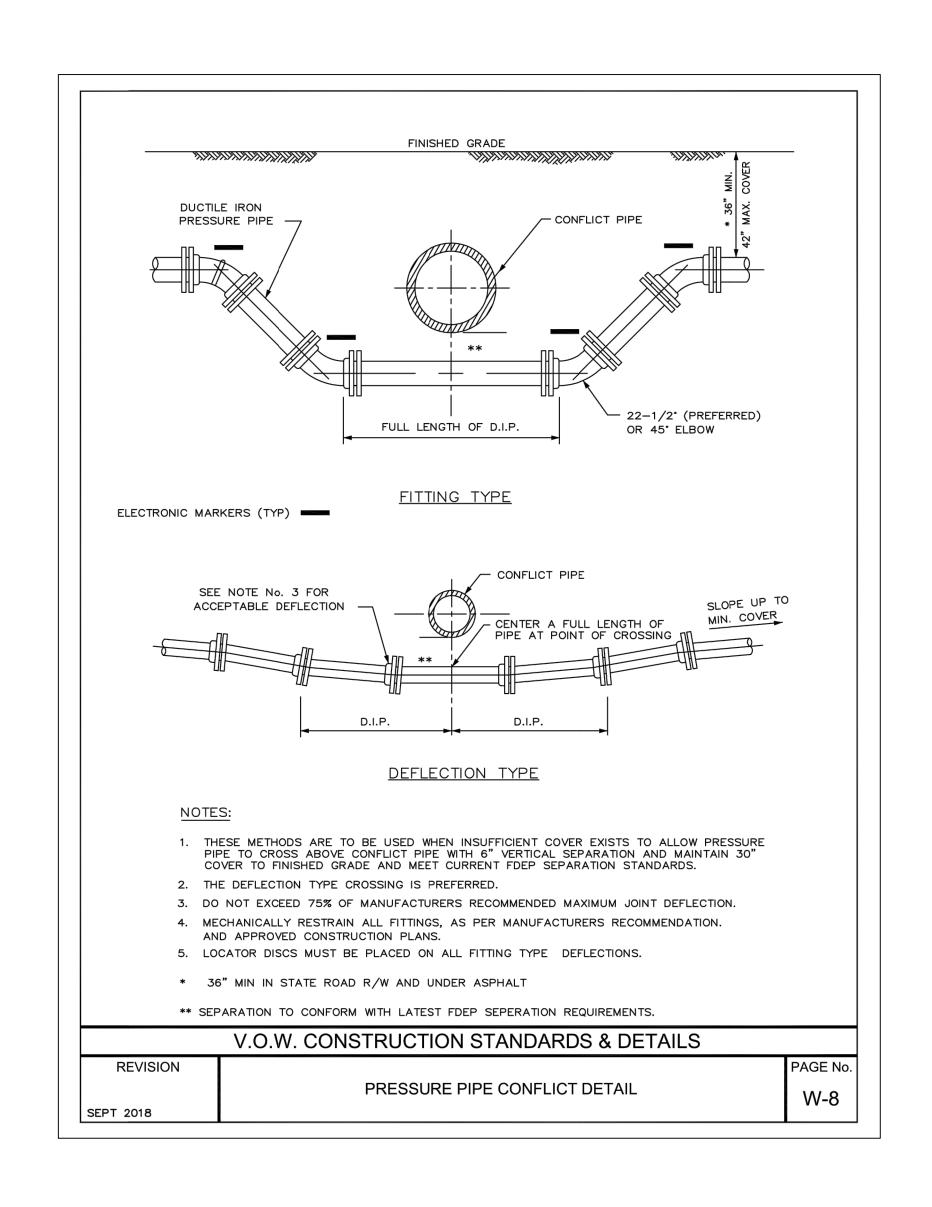FORCEMAIN REPLACEMENT PROJECT FOREST HILL BOULEVARD CROSSING AND C-2 CANAL CROSSING THE VILLAGE OF WELLINGTON PALM BEACH COUNTY, FLORIDA

DRAWN: TET

APPR: GGG

SCALE: N/A

DESIGN: SMS/TET

DATE: JANUARY 2019 B8705.00 P.A. NO. DWG. NO. 44-41-11-16 SHEET: C5-4

FLORIDA L.B. NO. 48 FIELD: --MOCK•ROOS SPENCER M. SCHROEDER FLORIDA P.E. NO. 65693 CONSULTING ENGINEERS 5720 Corporate Way, West Palm Beach, Florida 33407 (561) 683-3113, www.MockRoos.com DATE

PIPE SIZE FITTING TYPE 4" | 6" | 8" | 10" | 12" | 16" | 20" | 24" | 30" | 36" | 42" | 48"
 14
 20
 25
 30
 35
 45
 54
 62
 98
 112
 124
 135
 90° HORIZ. BEND 45° HORIZ. BEND 6 8 11 13 15 19 22 26 41 46 51 56 22.5° HORIZ. BEND | 3 | 4 | 5 | 6 | 7 | 9 | 11 | 12 | 19 | 22 | 25 | 27 11.25° HORIZ. BEND | 1 | 2 | 3 | 3 | 4 | 4 | 5 | 6 | 10 | 11 | 12 | 13 29 | 41 | 53 | 64 | 74 | 95 | 115 | 134 | 214 | 246 | 276 | 304 12 | 19 | 24 | 29 | 34 | 39 | 48 | 56 | 89 | 102 | 114 | 126 3 4 6 7 8 10 12 15 23 27 31 34 6 9 12 14 17 19 23 27 43 49 55 60 22.5° VERT. LOWER BEND 1 2 4 4 4 5 6 7 11 13 15 16 11.25° VERT. OFFSET LOWER 1 1 1 4 2 LOWER BEND 1 1 1 2 2 2 3 3 6 6 PLUG (DEAD END) 32 45 59 70 83 107 129 151 214 246 276 304 IN-LINE VALVE 32 45 45 45 45 55 65 80 110 125 140 155 10"X ø 16 32 46 58 - - - - - - - -12"X ø 13 30 44 57 69 - - -16"X ø 7 26 41 55 67 90 - -(BRANCH RESTRAINT) 20"X Ø 1 21 38 52 65 88 109 -24"X ø 1 16 34 49 62 86 108 129 30"X Ø 1 8 28 44 58 83 106 127 208 -36"X Ø 1 1 22 39 54 80 103 124 206 240 - - 42"X Ø 1 1 15 33 49 77 100 122 205 239 270 -

 42"X Ø
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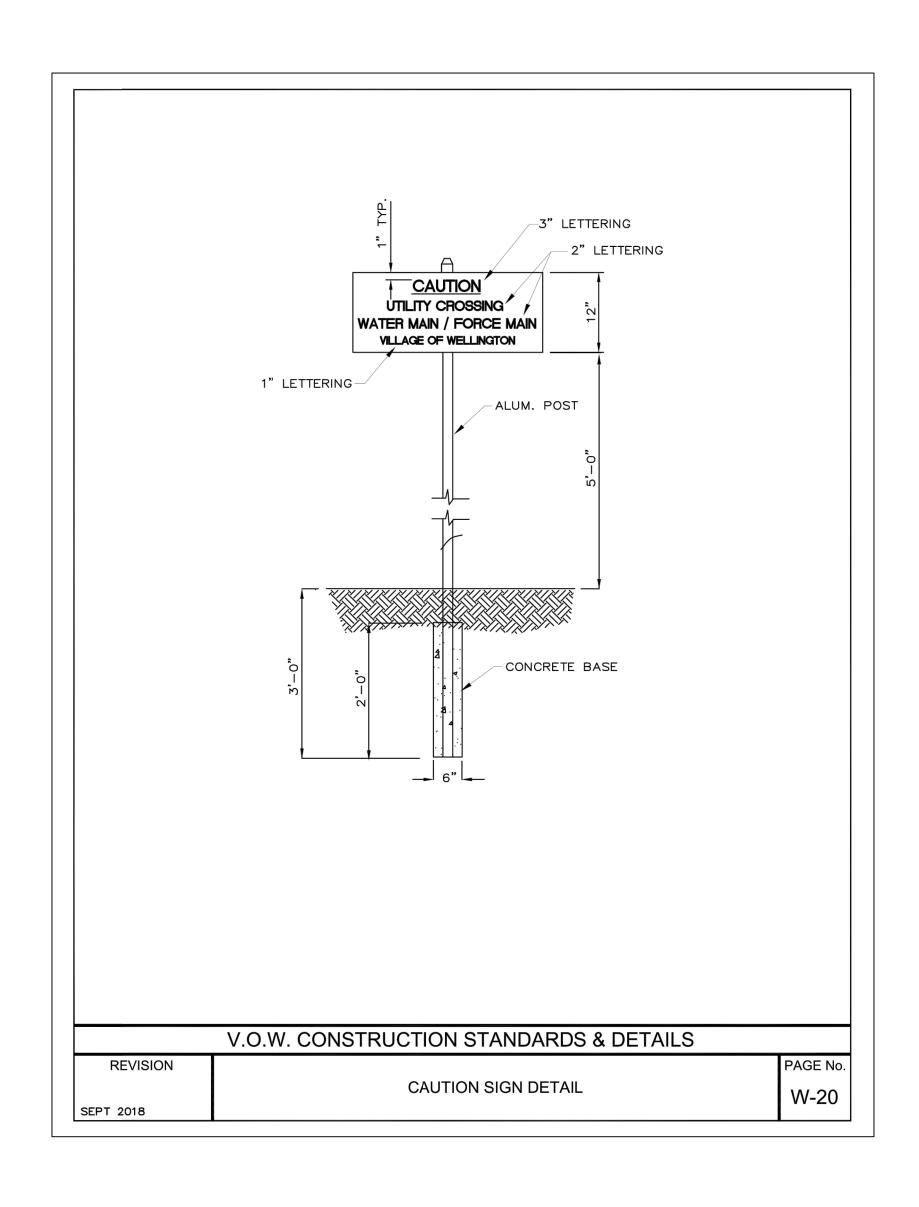
 48"X ø
 301
 298
 294
 289
 283
 268
 249
 226
 183
 131
 71
 NOTES:

1. THE DATA IN THE ABOVE TABLE ARE BASED UPON THE FOLLOWING INSTALLATION CONDITIONS:
SOIL TYPE—SAND (SW) TEST PRESSURE—150 PSI/200 PSI DEPTH OF BURY—3'
TRENCH TYPE—3 SAFETY FACTOR— 1.5 VERTICAL OFFSET—3'
MINIMUM PIPE LENGTH ALONG TEE RUN—5'

2. THE RESTRAINED PIPE LENGTHS APPLY TO DUCTILE IRON AND PVC PIPE.
3. ALL JOINTS BETWEEN UPPER AND LOWER BENDS SHALL BE RESTRAINED.
4. RESTRAINED PIPE LENGTHS APPLY TO PIPE ON BOTH SIDES OF VALVES AND FITTINGS.
5. MULTIPLY PIPE LENGTH BY 1.4 FOR POLYETHYLENE ENCASED PIPE.
6. RESTRAINED PIPE LENGTHS EQUAL TO AN "INLINE VALVE" CONDITION ARE REQUIRED AT EACH END OF A TRANSITION FROM HDPE PIPE TO OTHER PIPE MATERIALS.
7. DESIGN ENGINEER IS RESPONSIBLE TO PROPERLY SIZE THE RESTRAINT PIPE LENGTHS FOR THE PROJECT, INCLUDING SPECIFIC PROJECT SOIL CONDITIONS. V.O.W. CONSTRUCTION STANDARDS & DETAILS PAGE No. REVISION MECHANICAL JOINT RESTRAINT REQUIREMENTS W-9 SEPT 2018

REVISION

MIN. LENGTH OF PIPE (FEET) TO BE RESTRAINED (SOURCES: EBAA IRON RESTRAINT LENGTH CALCULATION PROGRAM FOR PVC PIPE, RELEASE 3.1, AND DIPRA THRUST RESTRAINT FOR DUCTILE IRON PIPE, RELEASE 3.2)



VILLAGE OF WELLINGTON STANDARD DETAILS

FIELD: --DRAWN: TET DESIGN: SMS/TET APPR: GGG

FORCEMAIN REPLACEMENT PROJECT FOREST HILL BOULEVARD CROSSING AND C-2 CANAL CROSSING THE VILLAGE OF WELLINGTON PALM BEACH COUNTY, FLORIDA

DATE: JANUARY 2019 B8705.00 P.A. NO. DWG. NO. 44-41-11-16 SHEET: C5-5

BAR IS EQUAL TO ONE INCH ON ORIGINAL DRAWING ADJUST ALL SCALED IMENSIONS ACCORDINGLY

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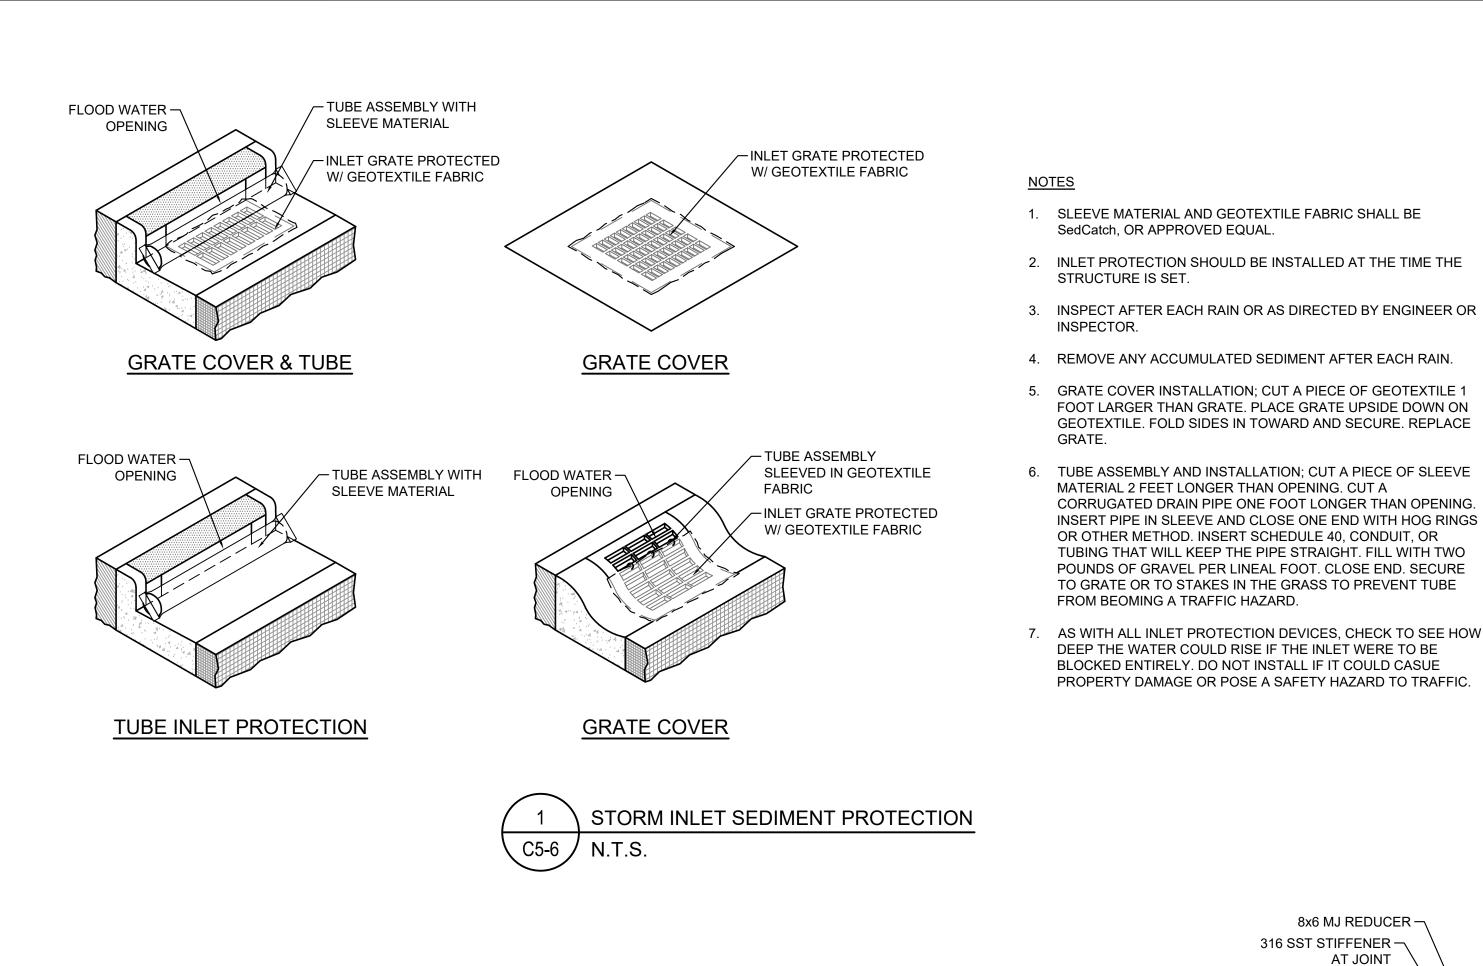
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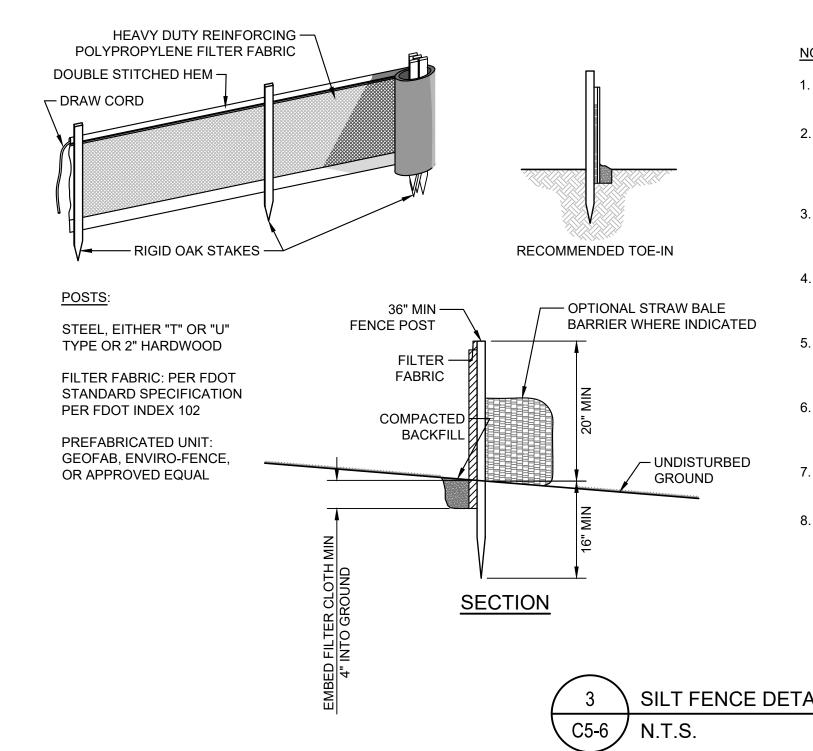
SEAL SPENCER M. SCHROEDER FLORIDA P.E. NO. 65693 DATE


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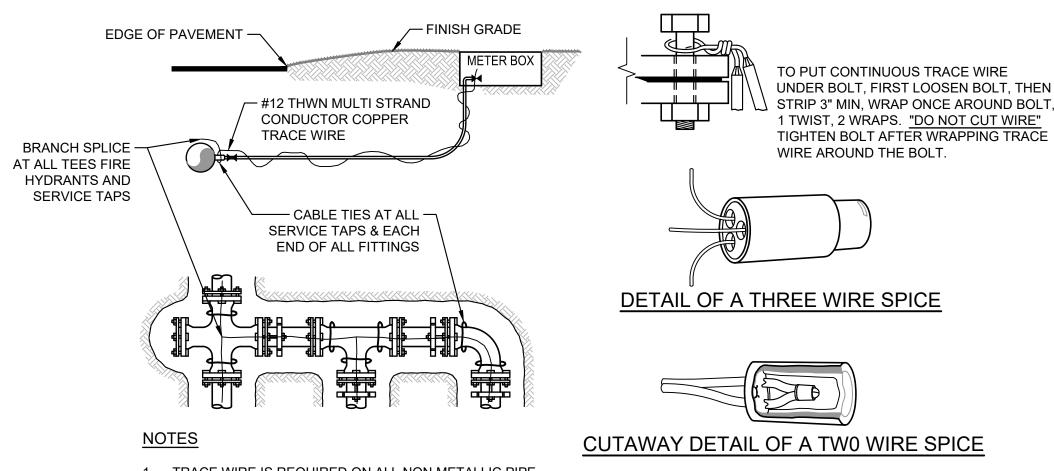
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FLORIDA L.B. NO. 48 SCALE: N/A







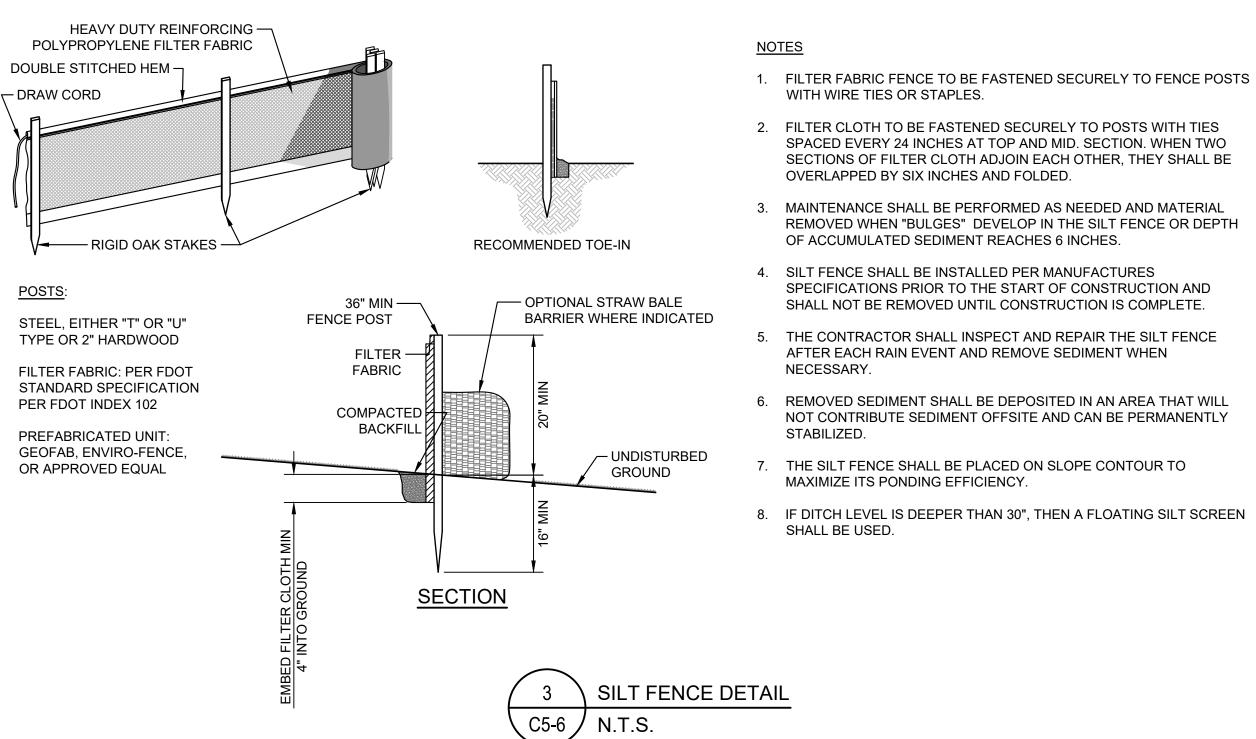

1. TRACE WIRE IS REQUIRED ON ALL NON METALLIC PIPE.

BAR IS EQUAL TO ONE INCH ON ORIGINAL DRAWING ADJUST ALL SCALED

IMENSIONS ACCORDINGLY


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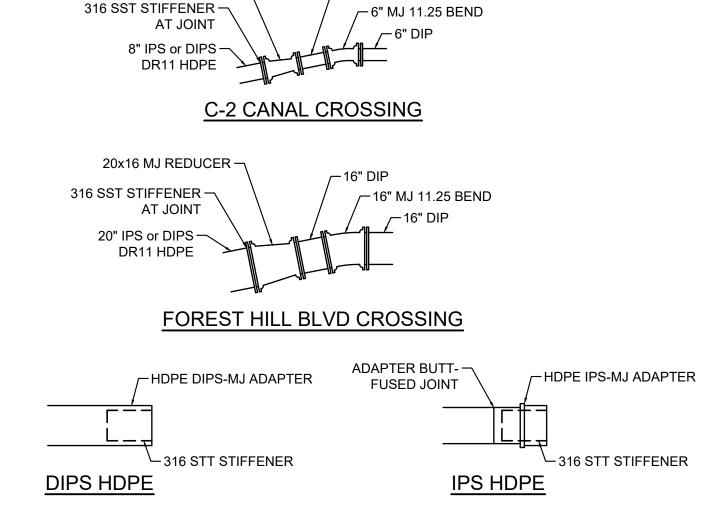
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NO. DATE BY

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- 2. INCLUDE ALL COST OF MATERIAL & LABOR IN PRICE OF PIPE.
- 3. CONTRACTOR IS RESPONSIBLE FOR CONTINUITY OF ALL TRACE WIRE.
- 4. WIRE SPLICE CONNECTORS SHALL BE DRY-CON DIRECT BURY LUG BY KING INNOVATIONS, DS-500 DRI-SPLICE BY SPEARS OR DIRECT BURY PRODUCTS BY 3M






<u>NOTES</u>

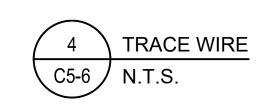- 1. HDPE MAY BE EITHER IPS OR DIPS WITH A MINIMUM ID OF 16" FOR THE FOREST HILL BLVD CROSSING AND 6" FOR THE C-2 CANAL CROSSING.
- 2. HDPE PIPE SIZE MUST BE ADAPTED TO THE ULTIMATE DIP SIZE AT MATERIAL TRANSITION.

8x6 MJ REDUCER

- 3. HDPE-MJ ADAPTORS SHALL BE DR11 AND RATED TO THE SAME PRESSURE AS THE PIPELINE. ADAPTORS SHALL BE BUTT FUSION-WELDED TO THE PIPE LINE.
- 4. HDPE TO MJ CONNECTIONS MUST CONTAIN STAINLESS STEEL STIFFENERS OF AN APPROPRIATE LENGTH FOR THE JOINT SIZE. THE STIFFENERS SHALL BE 316 STAINLESS STEEL AS MANUFACTURED BY ROMAC INDUSTRIES, JCM INDUSTRIES, FORD METER BOX COMPANY, OR APPROVED EQUAL.



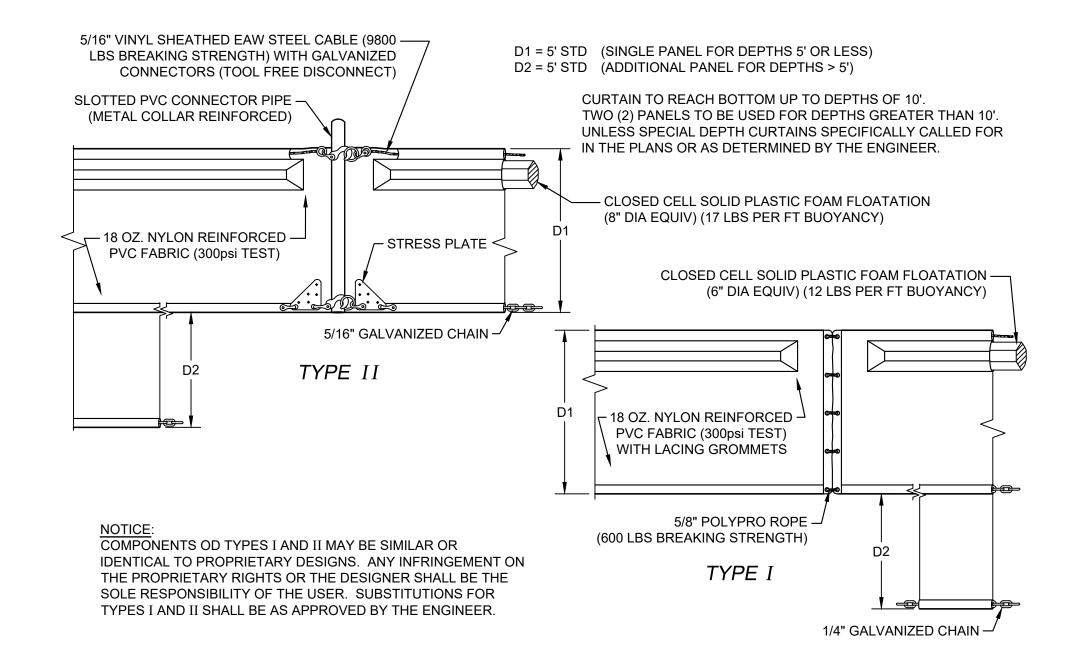

FLOATING TURBIDITY BARRIER C5-6 N.T.S.

LORIDA E.B. NO. 48

MOCK•ROOS

FLORIDA L.B. NO. 48

FIELD: --

DRAWN: TET

DESIGN: SMS/TET

FORCEMAIN REPLACEMENT PROJECT C-2 CANAL CROSSING THE VILLAGE OF WELLINGTON

DATE: JANUARY 2019 P.A. NO. B8705.00 DWG. NO. 44-41-11-16 SHEET: C5-6

SEAL SPENCER M. SCHROEDER FLORIDA P.E. NO. 65693

CONSULTING ENGINEERS

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7 | 3/12/2019 | SMS | REVISIONS PER VOW REVISION DATE FOREST HILL BOULEVARD CROSSING AND PALM BEACH COUNTY, FLORIDA

DETAILS

APPR: GGG SCALE: N/A